

1301 SOUTH CAPITOL STREET PROJECT





FILE NAME: SOUTH CAPITOL STREET.dwg

09.02.2022

A000

SOUTH CAPITOL STREET, SW WASHINGTON, DC

LOT 65,66,827,829 & 830 SQUARE 0653

SCOPE OF WORK

RAZE EXISTING STRUCTURES AND CONSTRUCT NEW MIXED USE BUILDING CONSISTING OF RESIDENTIAL, OFFICE AND RETAIL SPACE (CELLAR + 10 FLOORS + PENTHOUSE)

DRAWING INDEX

A000 COVER PAGE

A001 ZONING ANALYSIS & LOCATION A002 EXISTING SURROUNDING PHOTO

A003 LOCAL BRICK PATTERN & COLOR A004 EASEMENT & SURROUNDING PLATS

A100 PROPOSED & EXISTING SITE PLAN


A200 PROPOSED BASEMENT A201-210 PROPOSED FLOOR PLANS A211 PROPOSED PENTHOUSE PLAN


A212 PROPOSED ROOF PLAN A213 GAR SCORE-SHEET

A300- A305 PROPOSED ELEVATIONS

A400 PROPOSED SECTION A401 BUILDING MATERIAL A500-A509 PROPOSED 3D VIEWS A510-A512 SHADOW STUDY

SIS

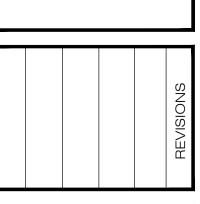

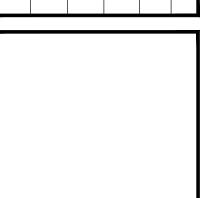

N.T.S

09.19.2022

A001





REQUIREMENT LOT OCCUPANCY 90% (max with IZ) 84% (6013 SF) N/A 7.195 7.2 (INCLUDING IZ) N/A F.A.R 51,343 SF 51,313 SF HEIGHT N/A 108.5 ft + PENTHOUSE 90ft with IZ bonus 110ft N/A 10 ft PENTHOUSE 20ft/ 1 STORY+MEZZ 0.4 FAR (2852 SF) 0.39 FAR (2781 SF) N/A SIDEYARD WIDTH NO REQUIREMENT 0'-0" (NO CHANGE) REAR YARD SETBACK N/A Ground floor-Zero feet 15ft MIN Upper floors- 15ft., except for balconies-11ft. 15 ft MIN ON SOUTH N/A FRONT YARD 15 ft MIN CAPITOL ST. SW. Width- 4in./ft. of height **CLOSED COURT** Ground floor-3ft by 45sf =36.2ft.* Upper floors- 15ft by 210sf. Area- (width 2)*2= 2,616 sq.ft.* PARKING COMMERCIAL N/A N/A NOT PROVIDED PARKING RESIDENTIAL N/A 18 LONG TERM AND 24 LONG TERM AND **BIKE PARKING** N/A 4 SHORT TERM 4 SHORT TERM 49 RESIDENTIAL UNITS + DWELLING UNITS 3 RESIDENTIAL AND N/A 3 COMMERCIAL SPACE 2 COMMERCIAL AND OFFICE FLOOR THREE - TWO BEDROOM UNITS (303, AFFORDABLE UNITS 405, & 502) AND THREE-ONE BEDROOM UNITS (604, 701 & 806). TOTAL OF SIX

FLOORS, STARTING 3RD FLOOR TO 8TH. NOTE: ALL FIXTURE & FURNITURE IN THE IZ UNITES ARE TO BE SAME AS NON-IZ UNITES

FLOOR AREA

TOTAL COMMERCIAL + OFFICE AREA=10,960SF

1ST FLOOR AREA = 6013 SF 2ND FLOOR AREA= 4947 SF *COMMERCIAL 1= 1398 SF *OFFICE FLOOR= 4245 SF *COMMERCIAL 2= 1580 SF 3RD-10TH FLOOR (Residencial) = 5044 SFx8 *COMMERCIAL 2= 975 SF

TOTAL RESIDENTIAL AREA = 40,352 SF


PENTHOUSE AREA = 2775 SF COMMON AREA = 1347 SF

UNITS, DISPERSED IN DIFFERENT

PH-RESIDENTIAL UNIT= 795 SF

GRAND TOTAL AREA = 51,313 SF


THE SITE

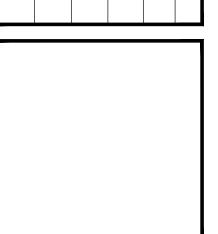



07.18.2022


A002

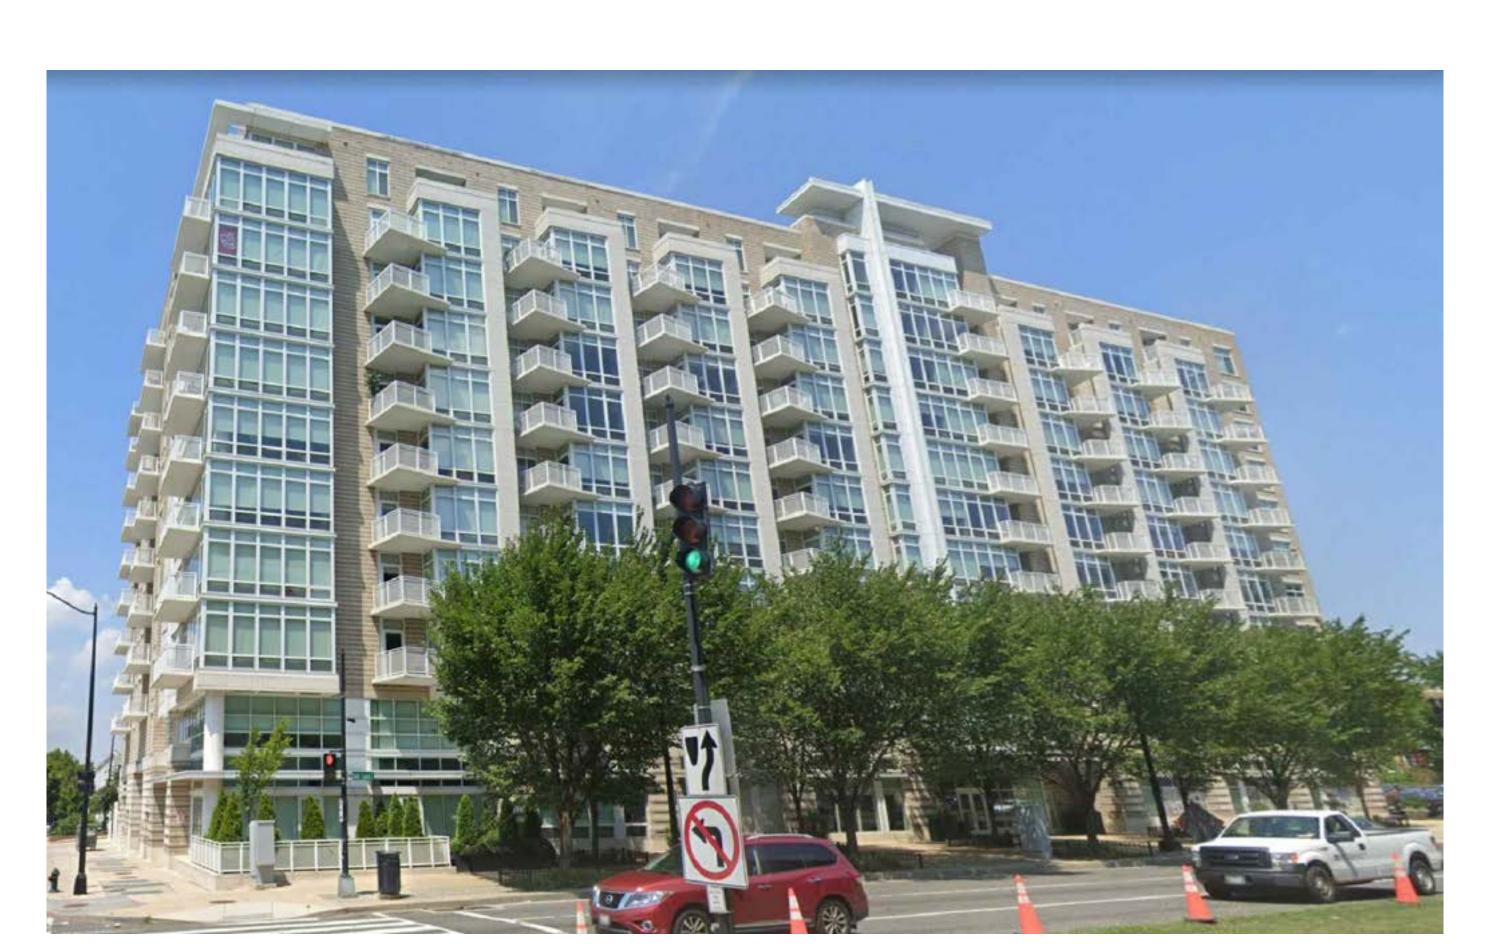


EXISTING ADJACENT BUILDINGS




NATIONALS PARK BASEBALL STADIUM

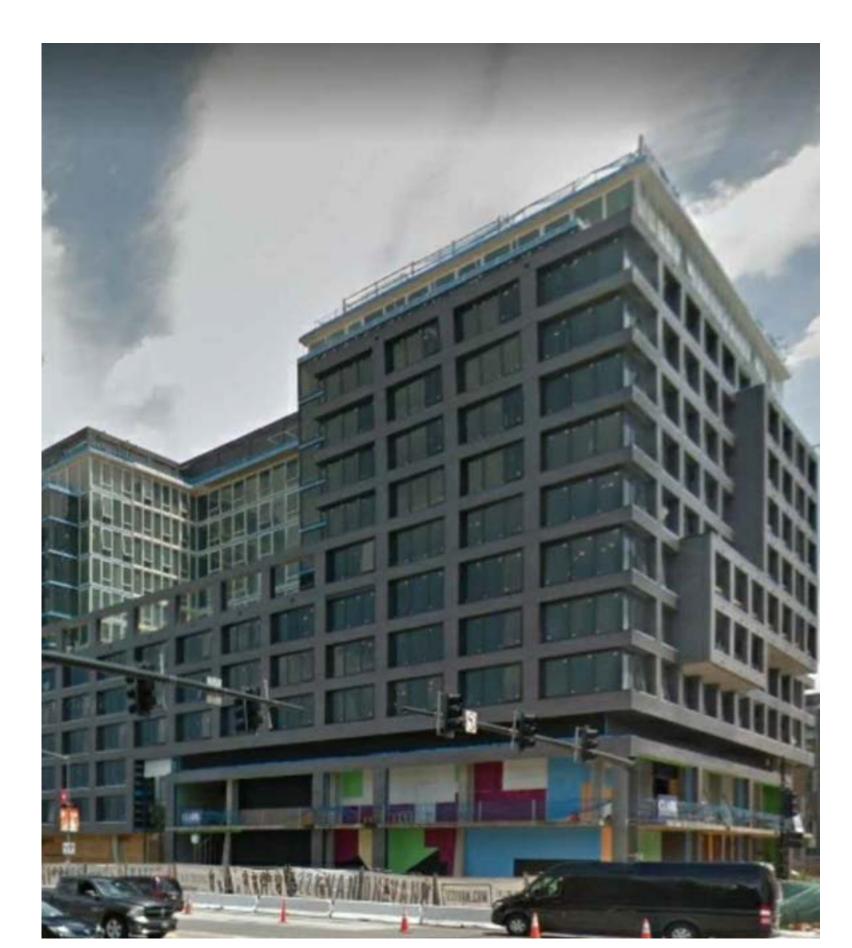

EXISTING BUILDINGS

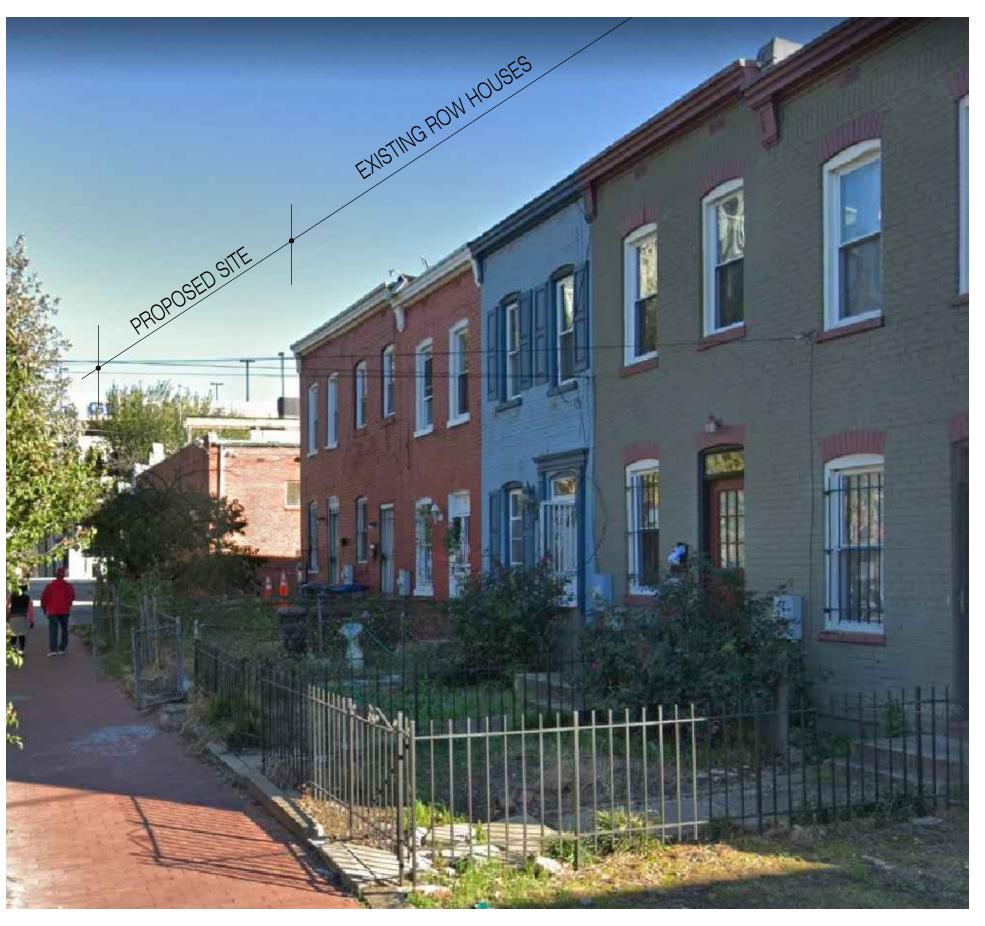


EXISTING ROW HOUSES (N-ST-SW)

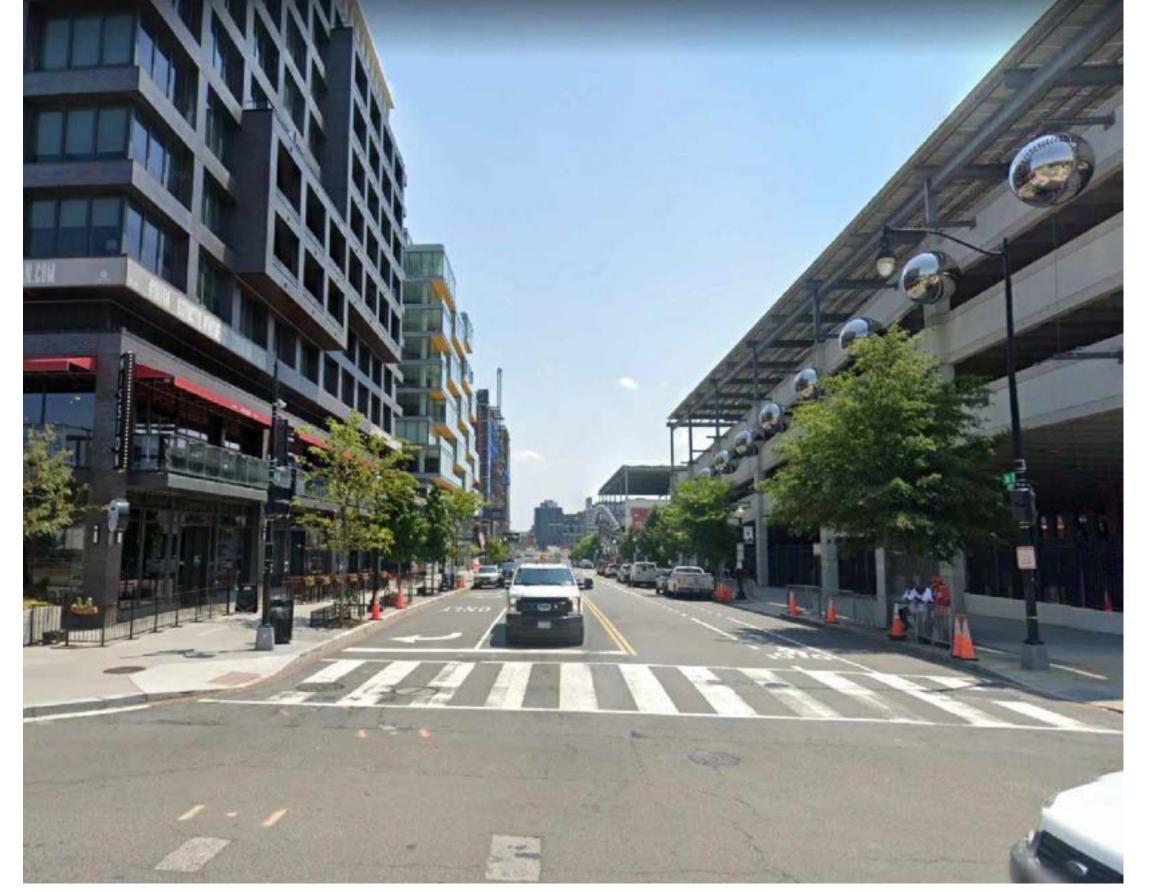

EXISTING BUILDINGS



1322 WILLIAM SYPHAX- SCHOOL HALF ST SW

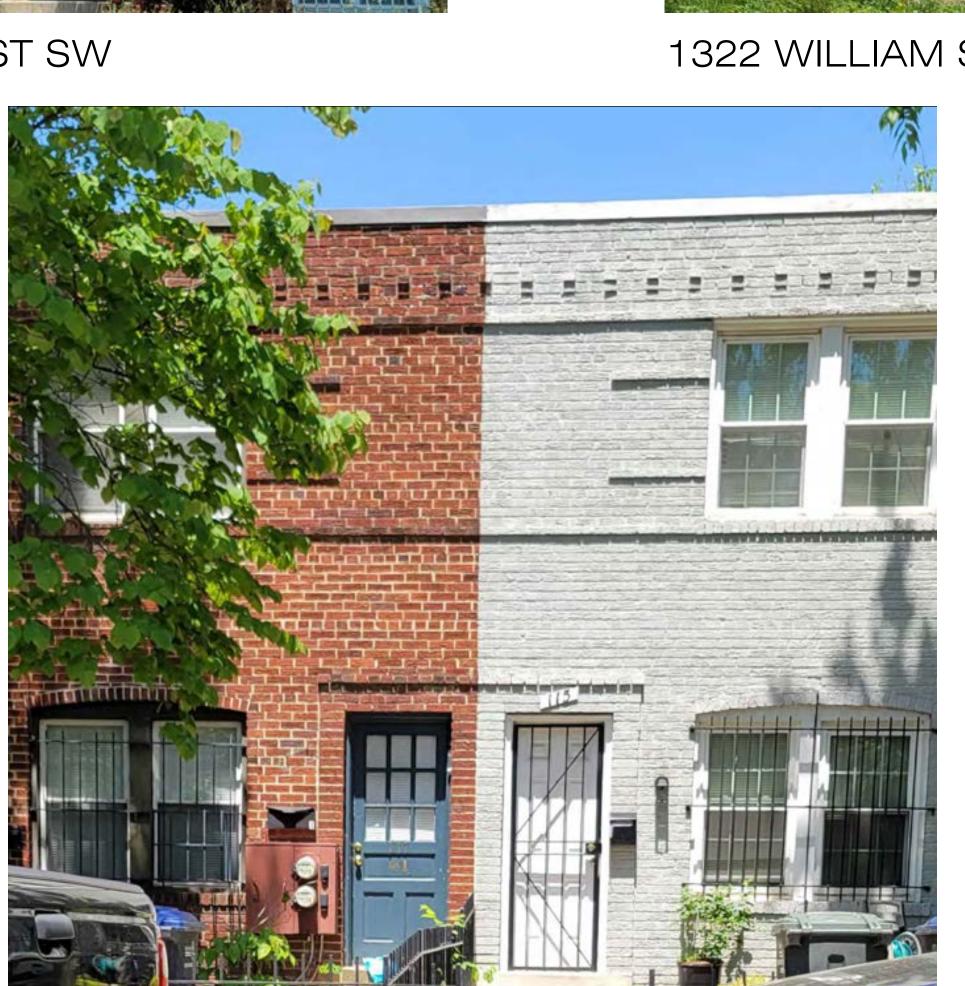

115 P- ST SW




1322 WILLIAM SYPHAX- SCHOOL HALF ST SW




111 O- ST SW

2601 P STREET NW, 2ND FLR WASHINGTON DC 20007 202.333.2877 V

RICH MARKUS ARCHITECTS

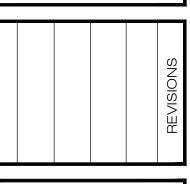

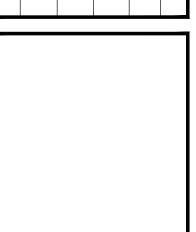

AS SHOWN


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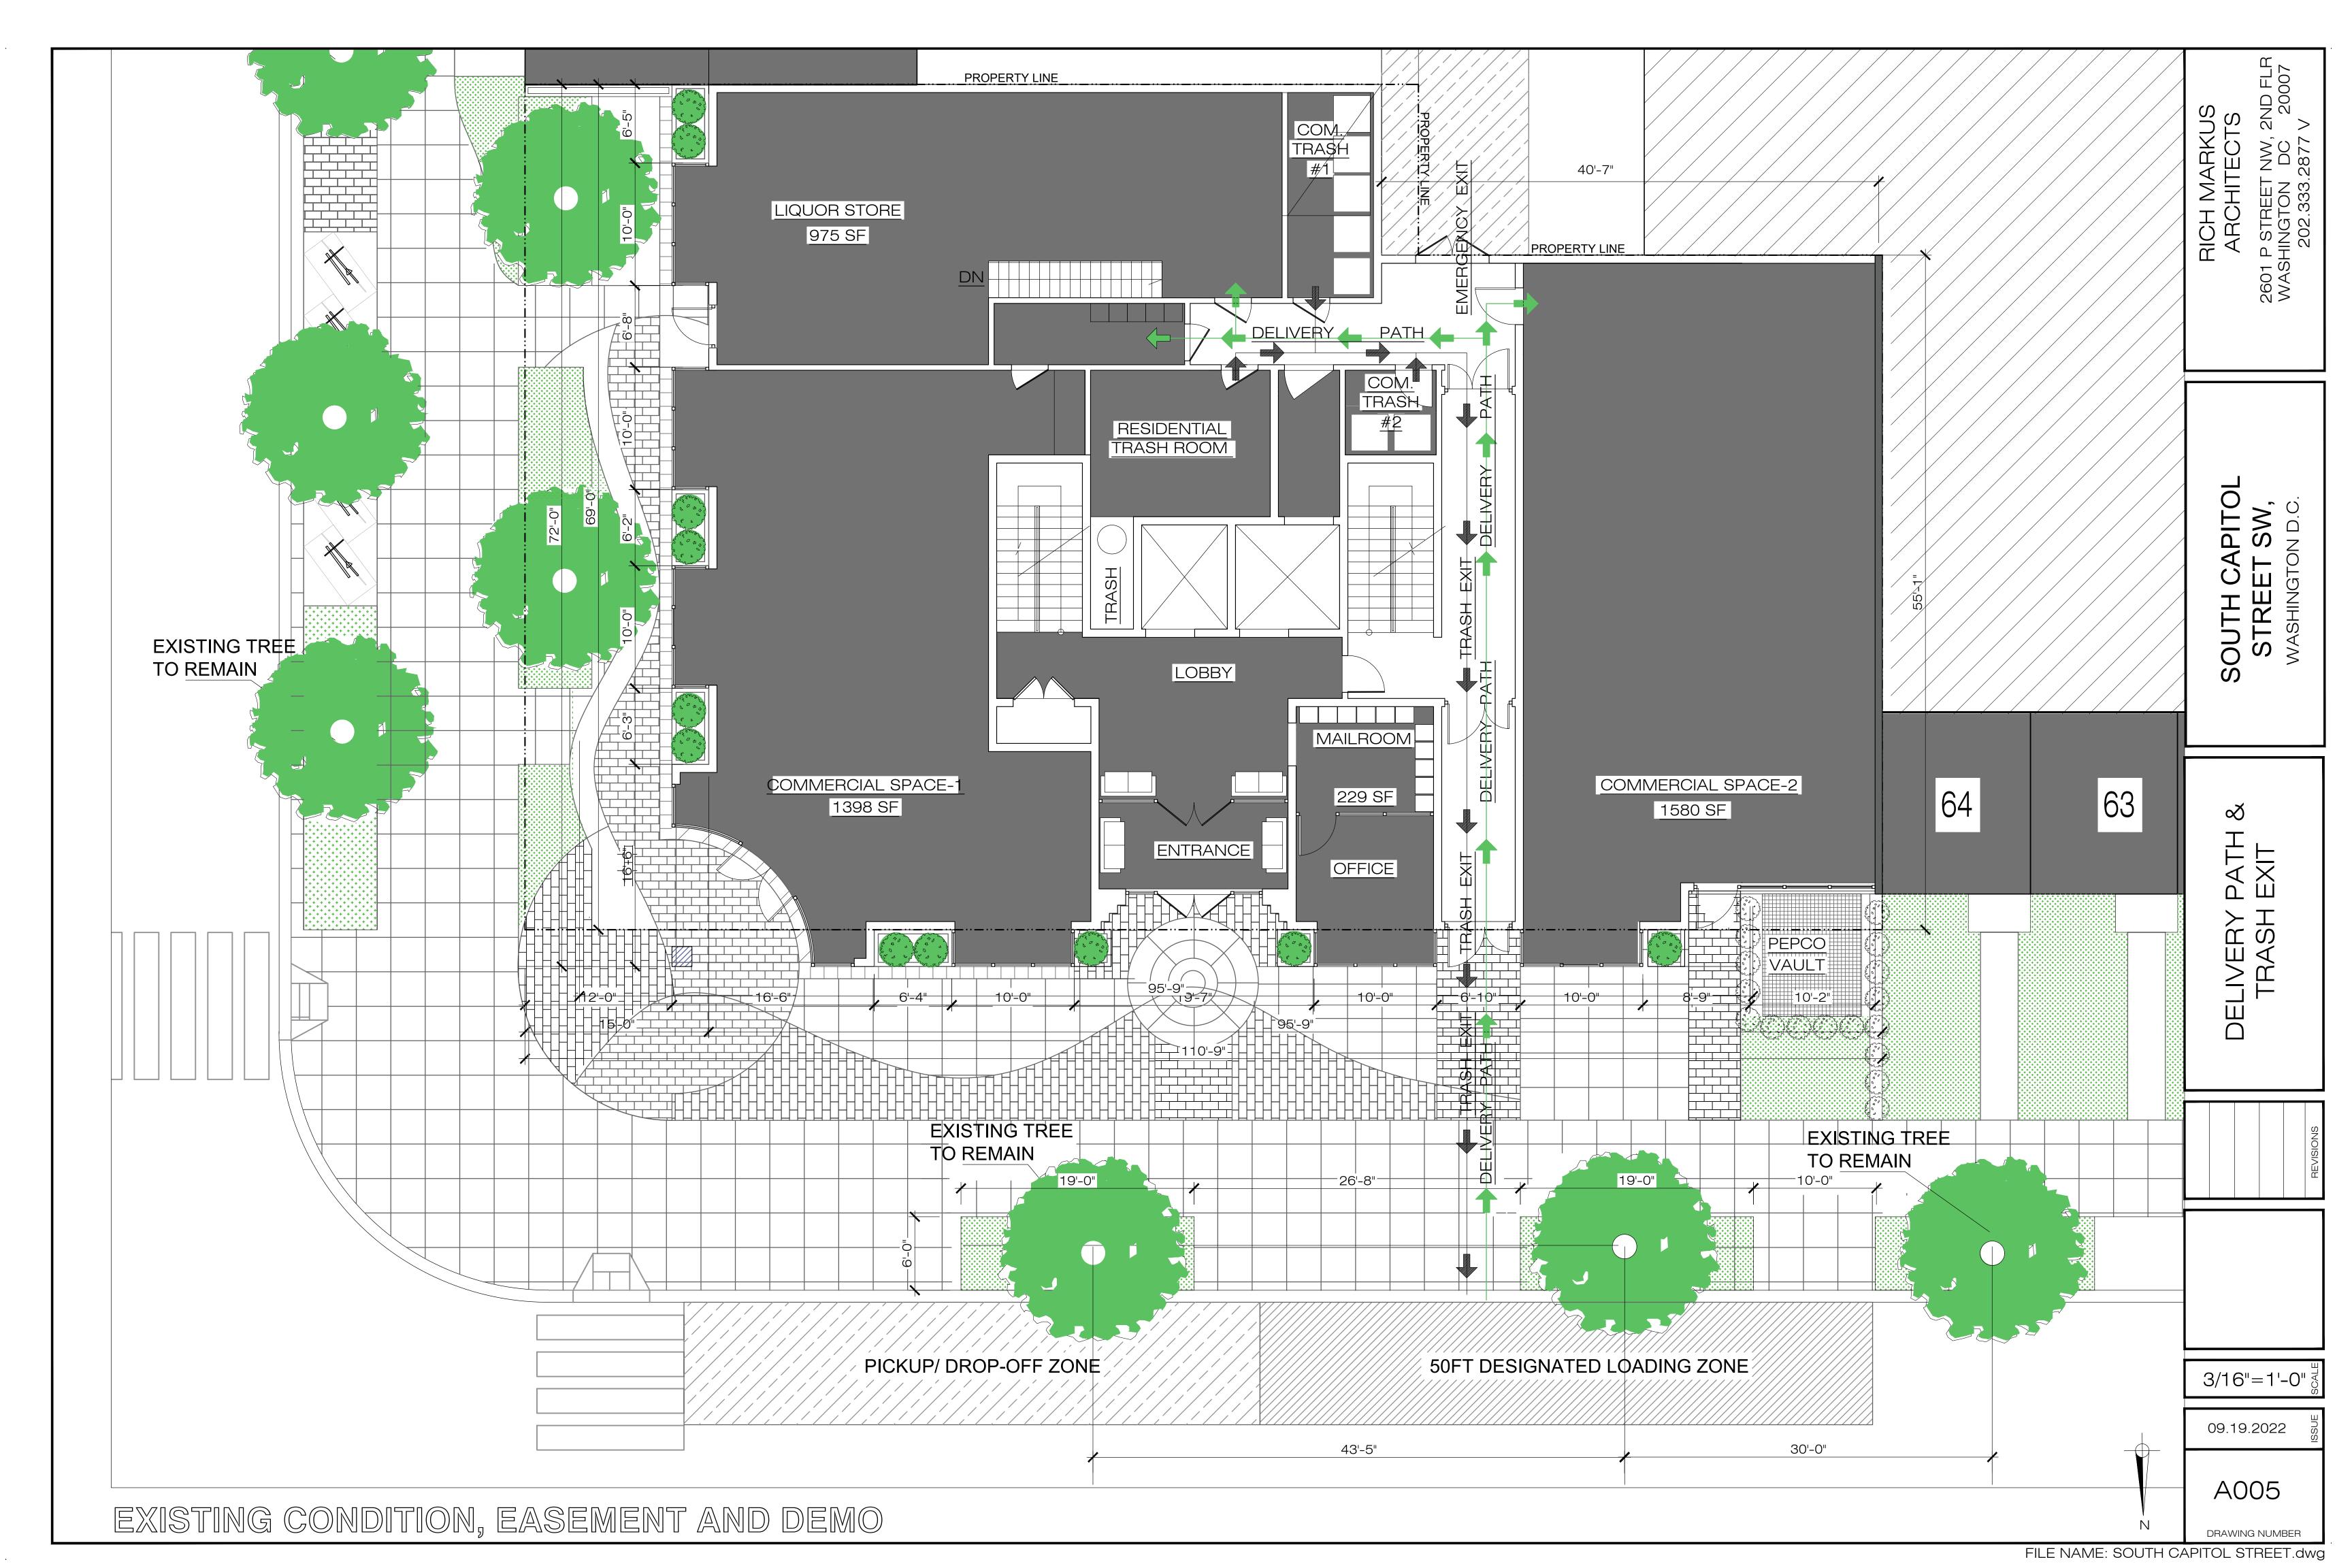
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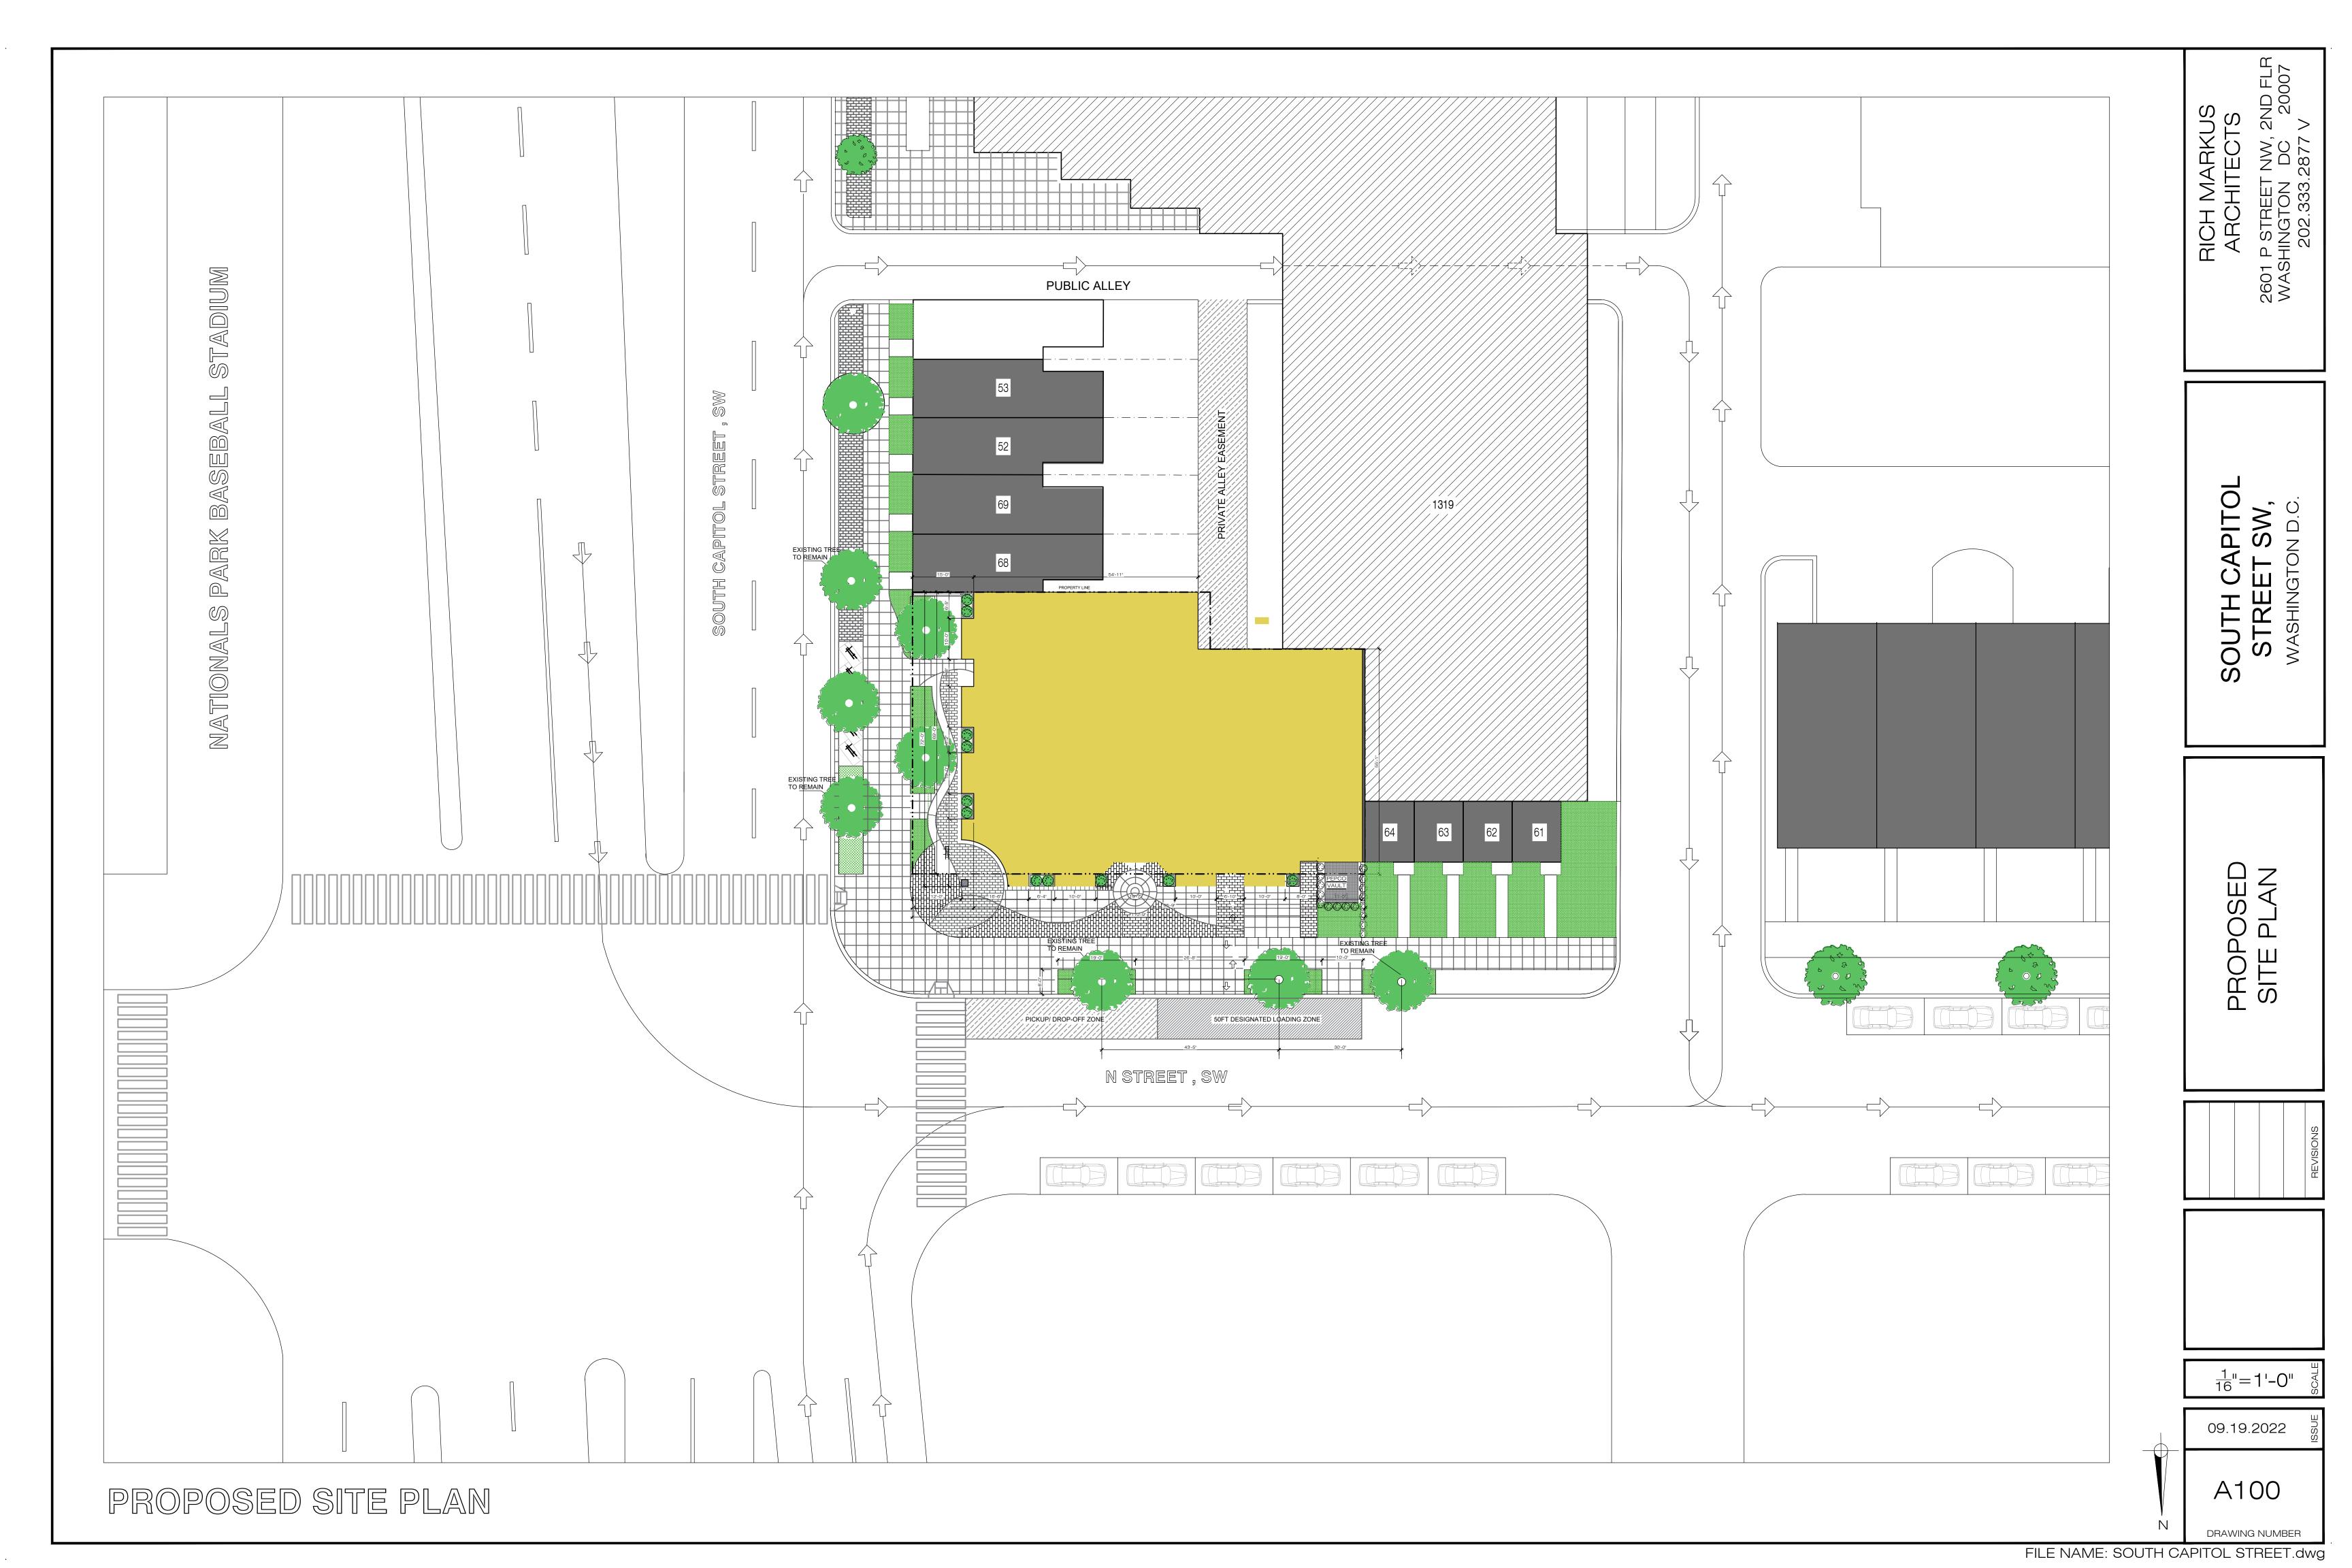
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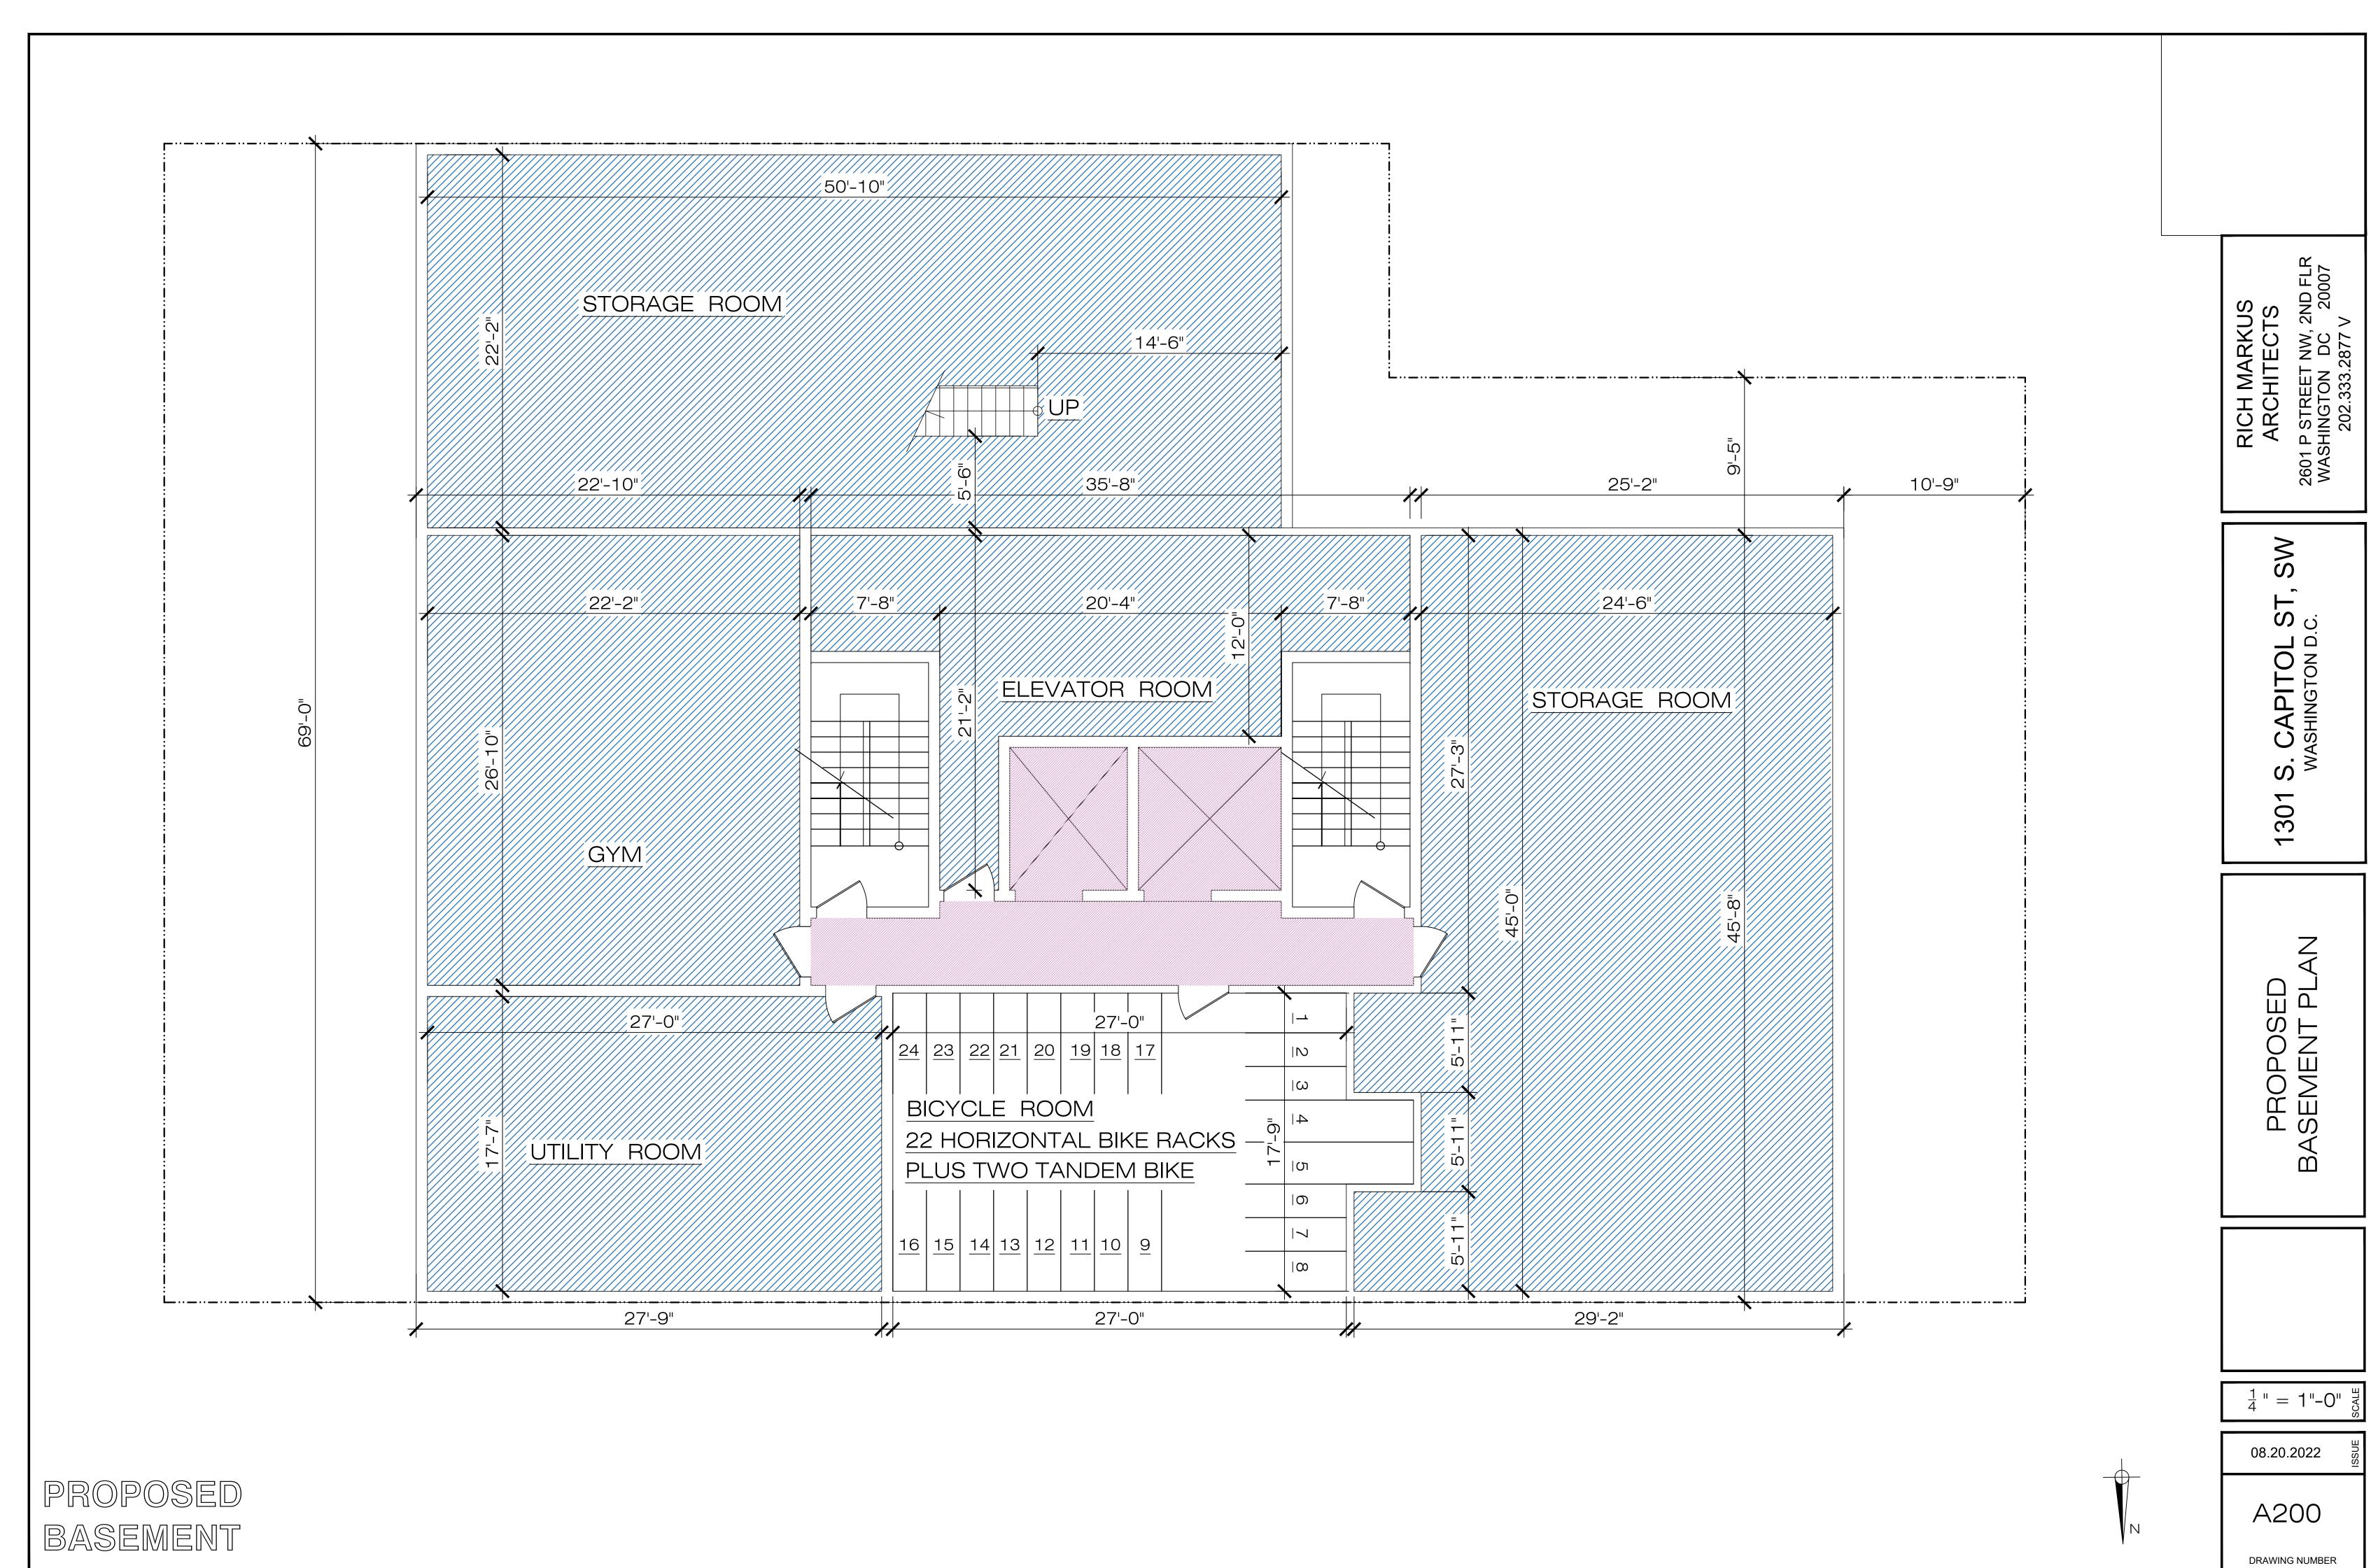
1420-

1420 CANAL ST SW









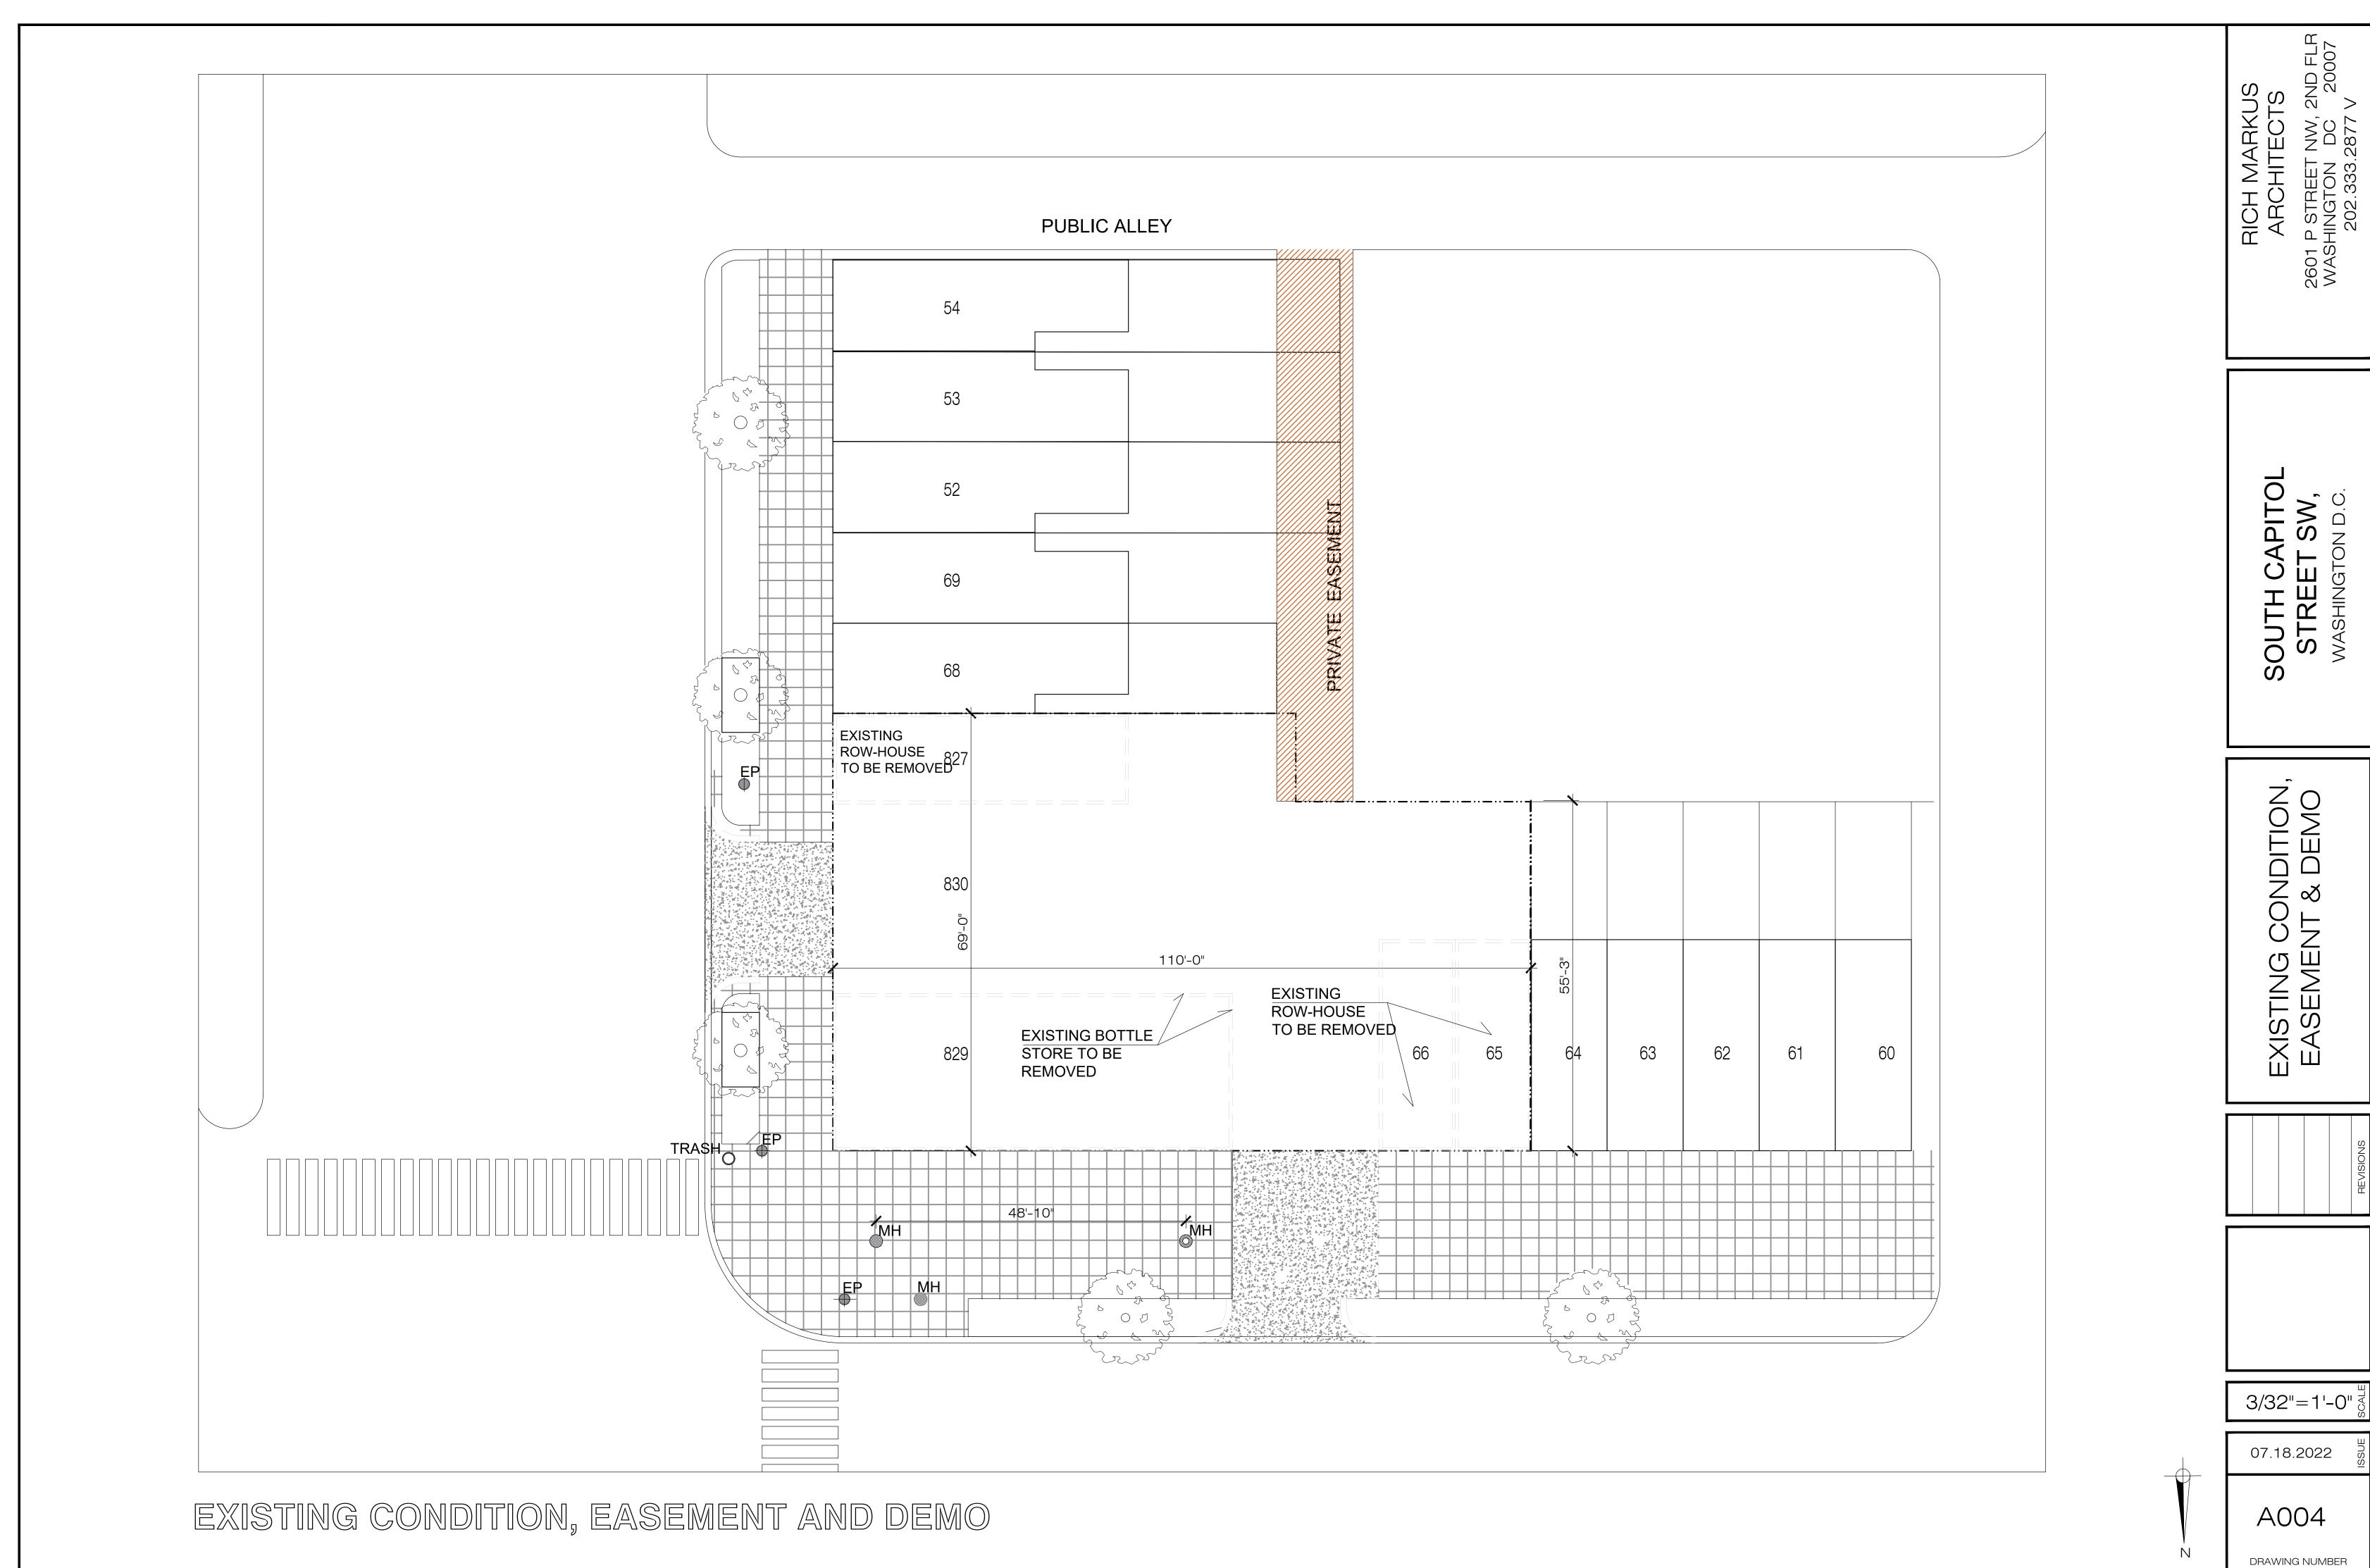



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PROPOSED ROOF PLAN

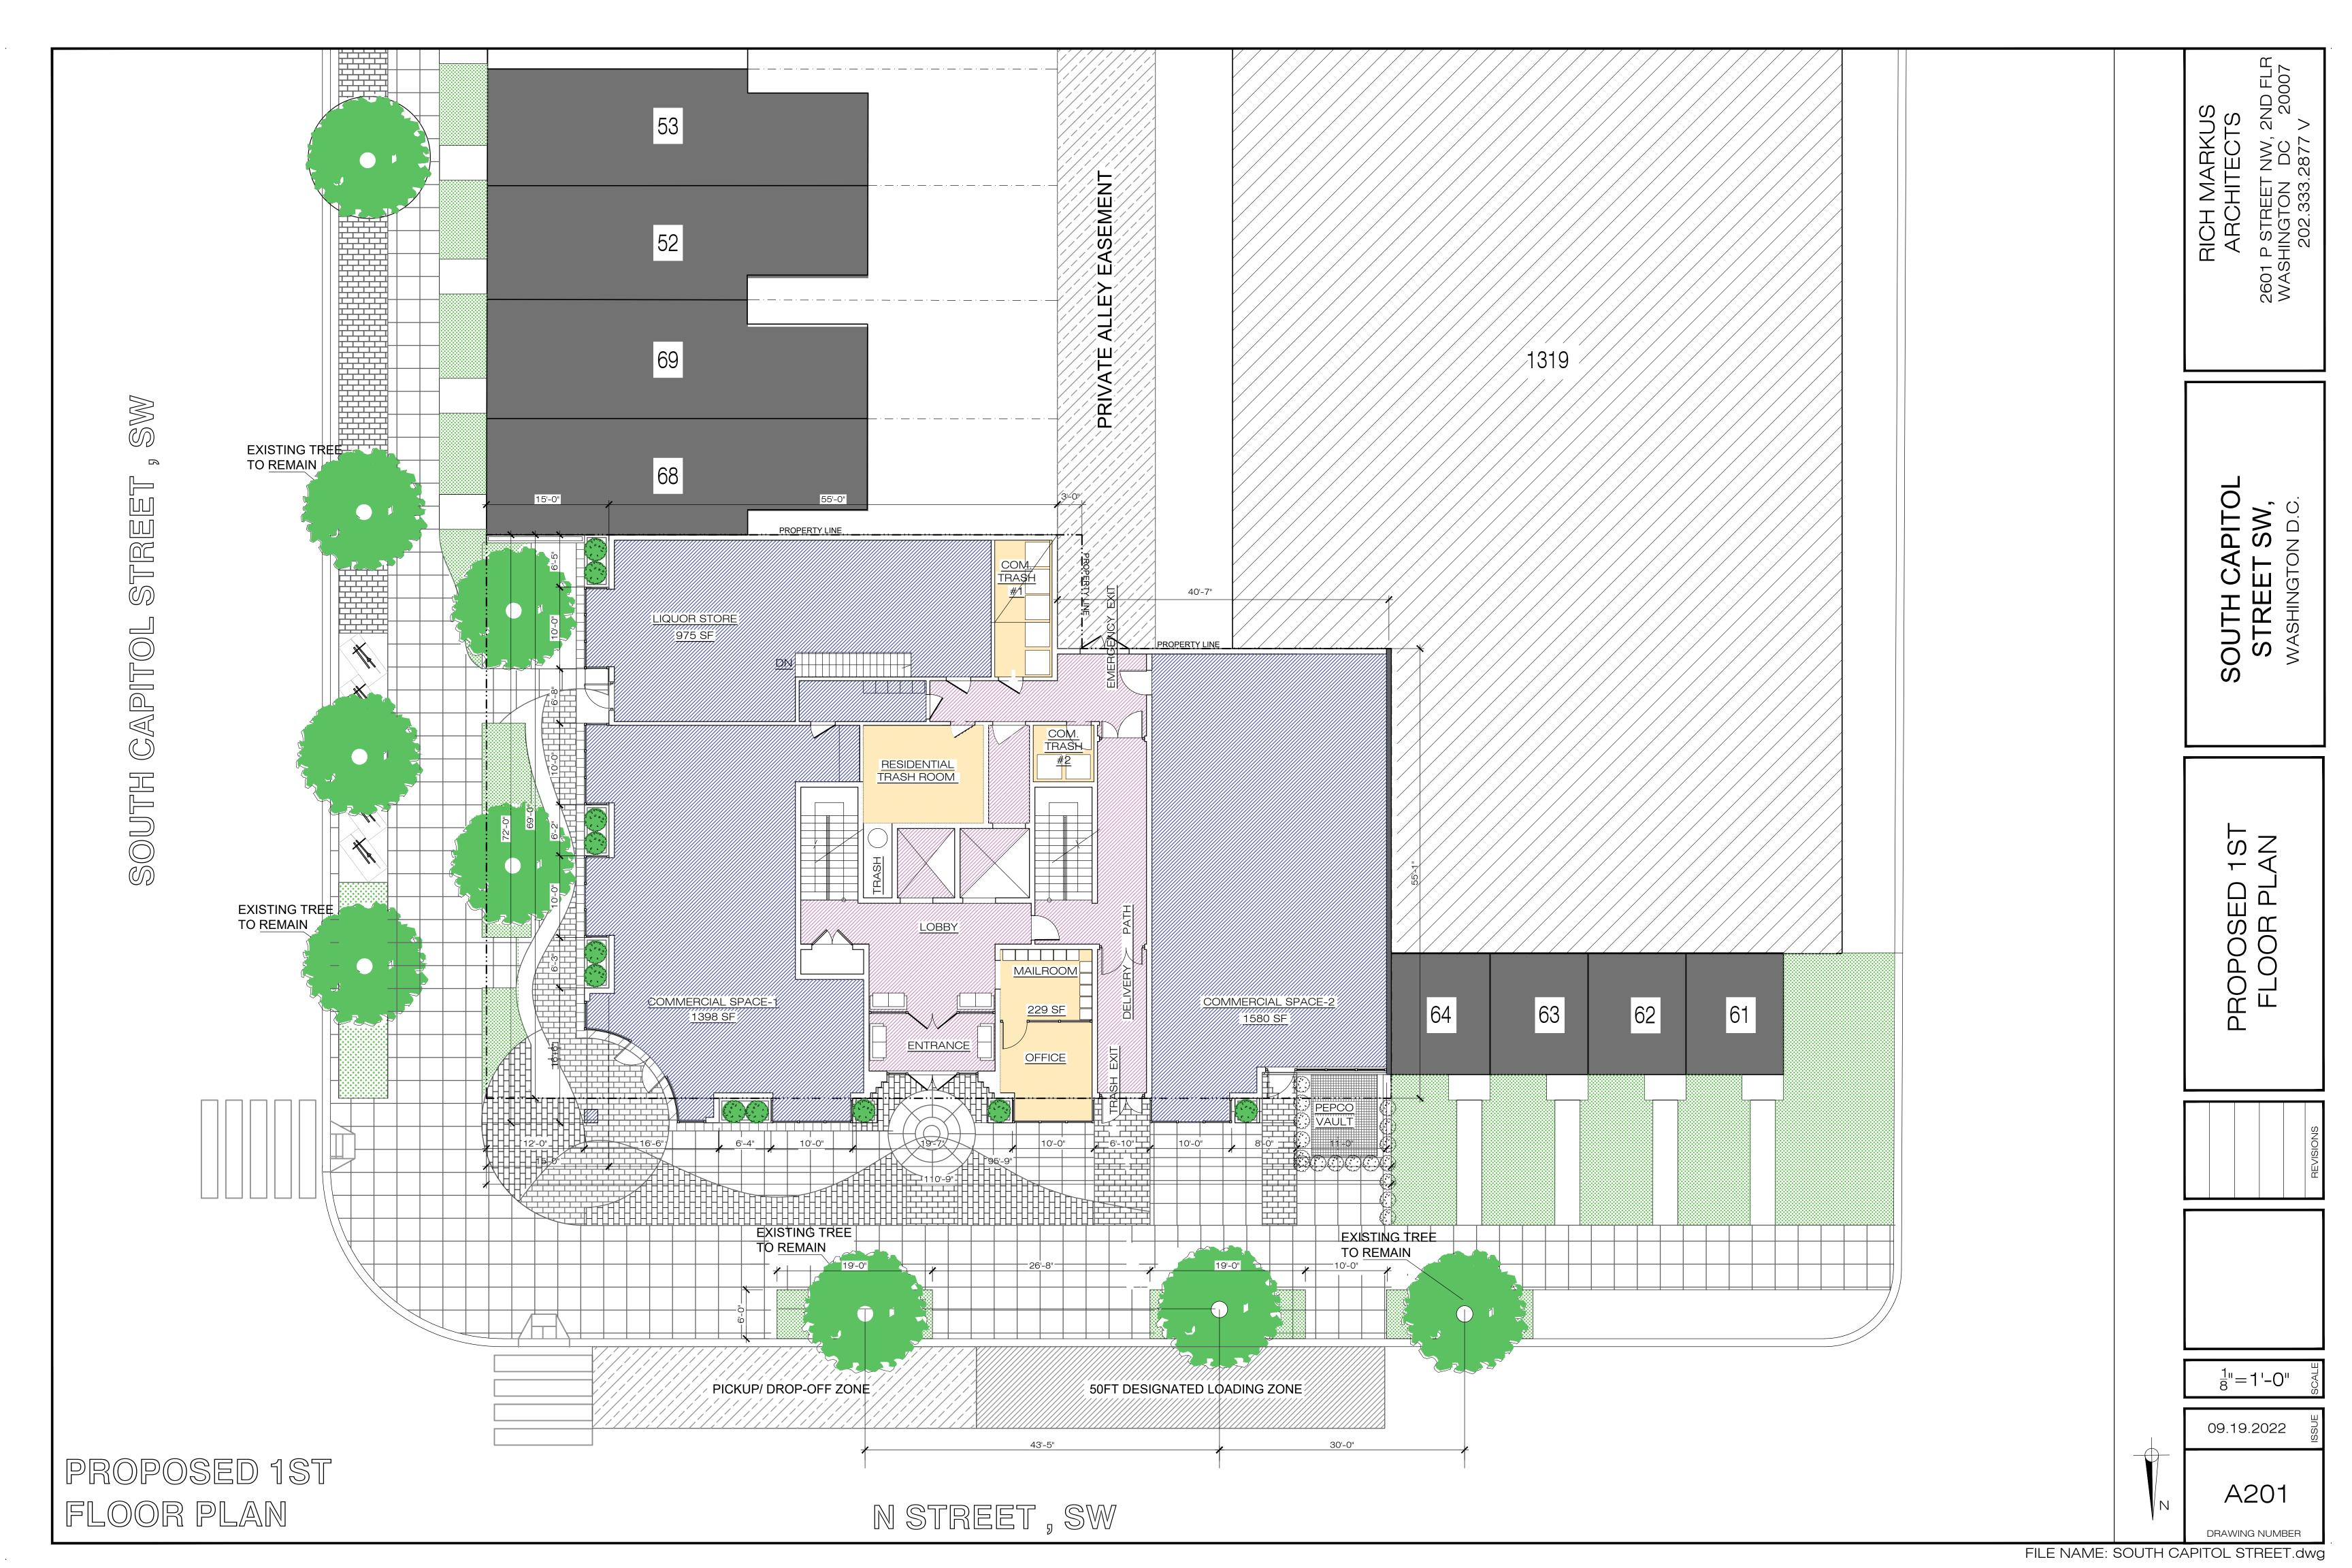PRELIMINARY SOLAR ENERGY CALCULATION				
ROOF AREA	1,400 sf + 900 sf = 2300 sf			
ROOF AREA COVERED WITH SOLAR PANELS	80% x 2300 sf =1,840 sf			
SOLAR CAPACITY @ 18 WATTS/sf	1,840 sf x 18 W= 33,120 WATTS OR 33kw			
ANNUAL PRODUCTION FOR 33kw SOLAR ARRAY IN WASHINGTON DC WILL AVERAGE 42,000 kwh/yr				
DESCRIPTION	ASSUMPTION			
ANNUAL ELECTRICITY GENERATION ESTIMATE	60,000 sf WILL CONSUME 25 kbtu/sf/yr= 440,000 kwh/yr			
THEREFORE, THE SOLAR PANELS WOULD BE OFFSETTING JUST UNDER 10% OF TOTAL BUILDING ENERGY USE.				

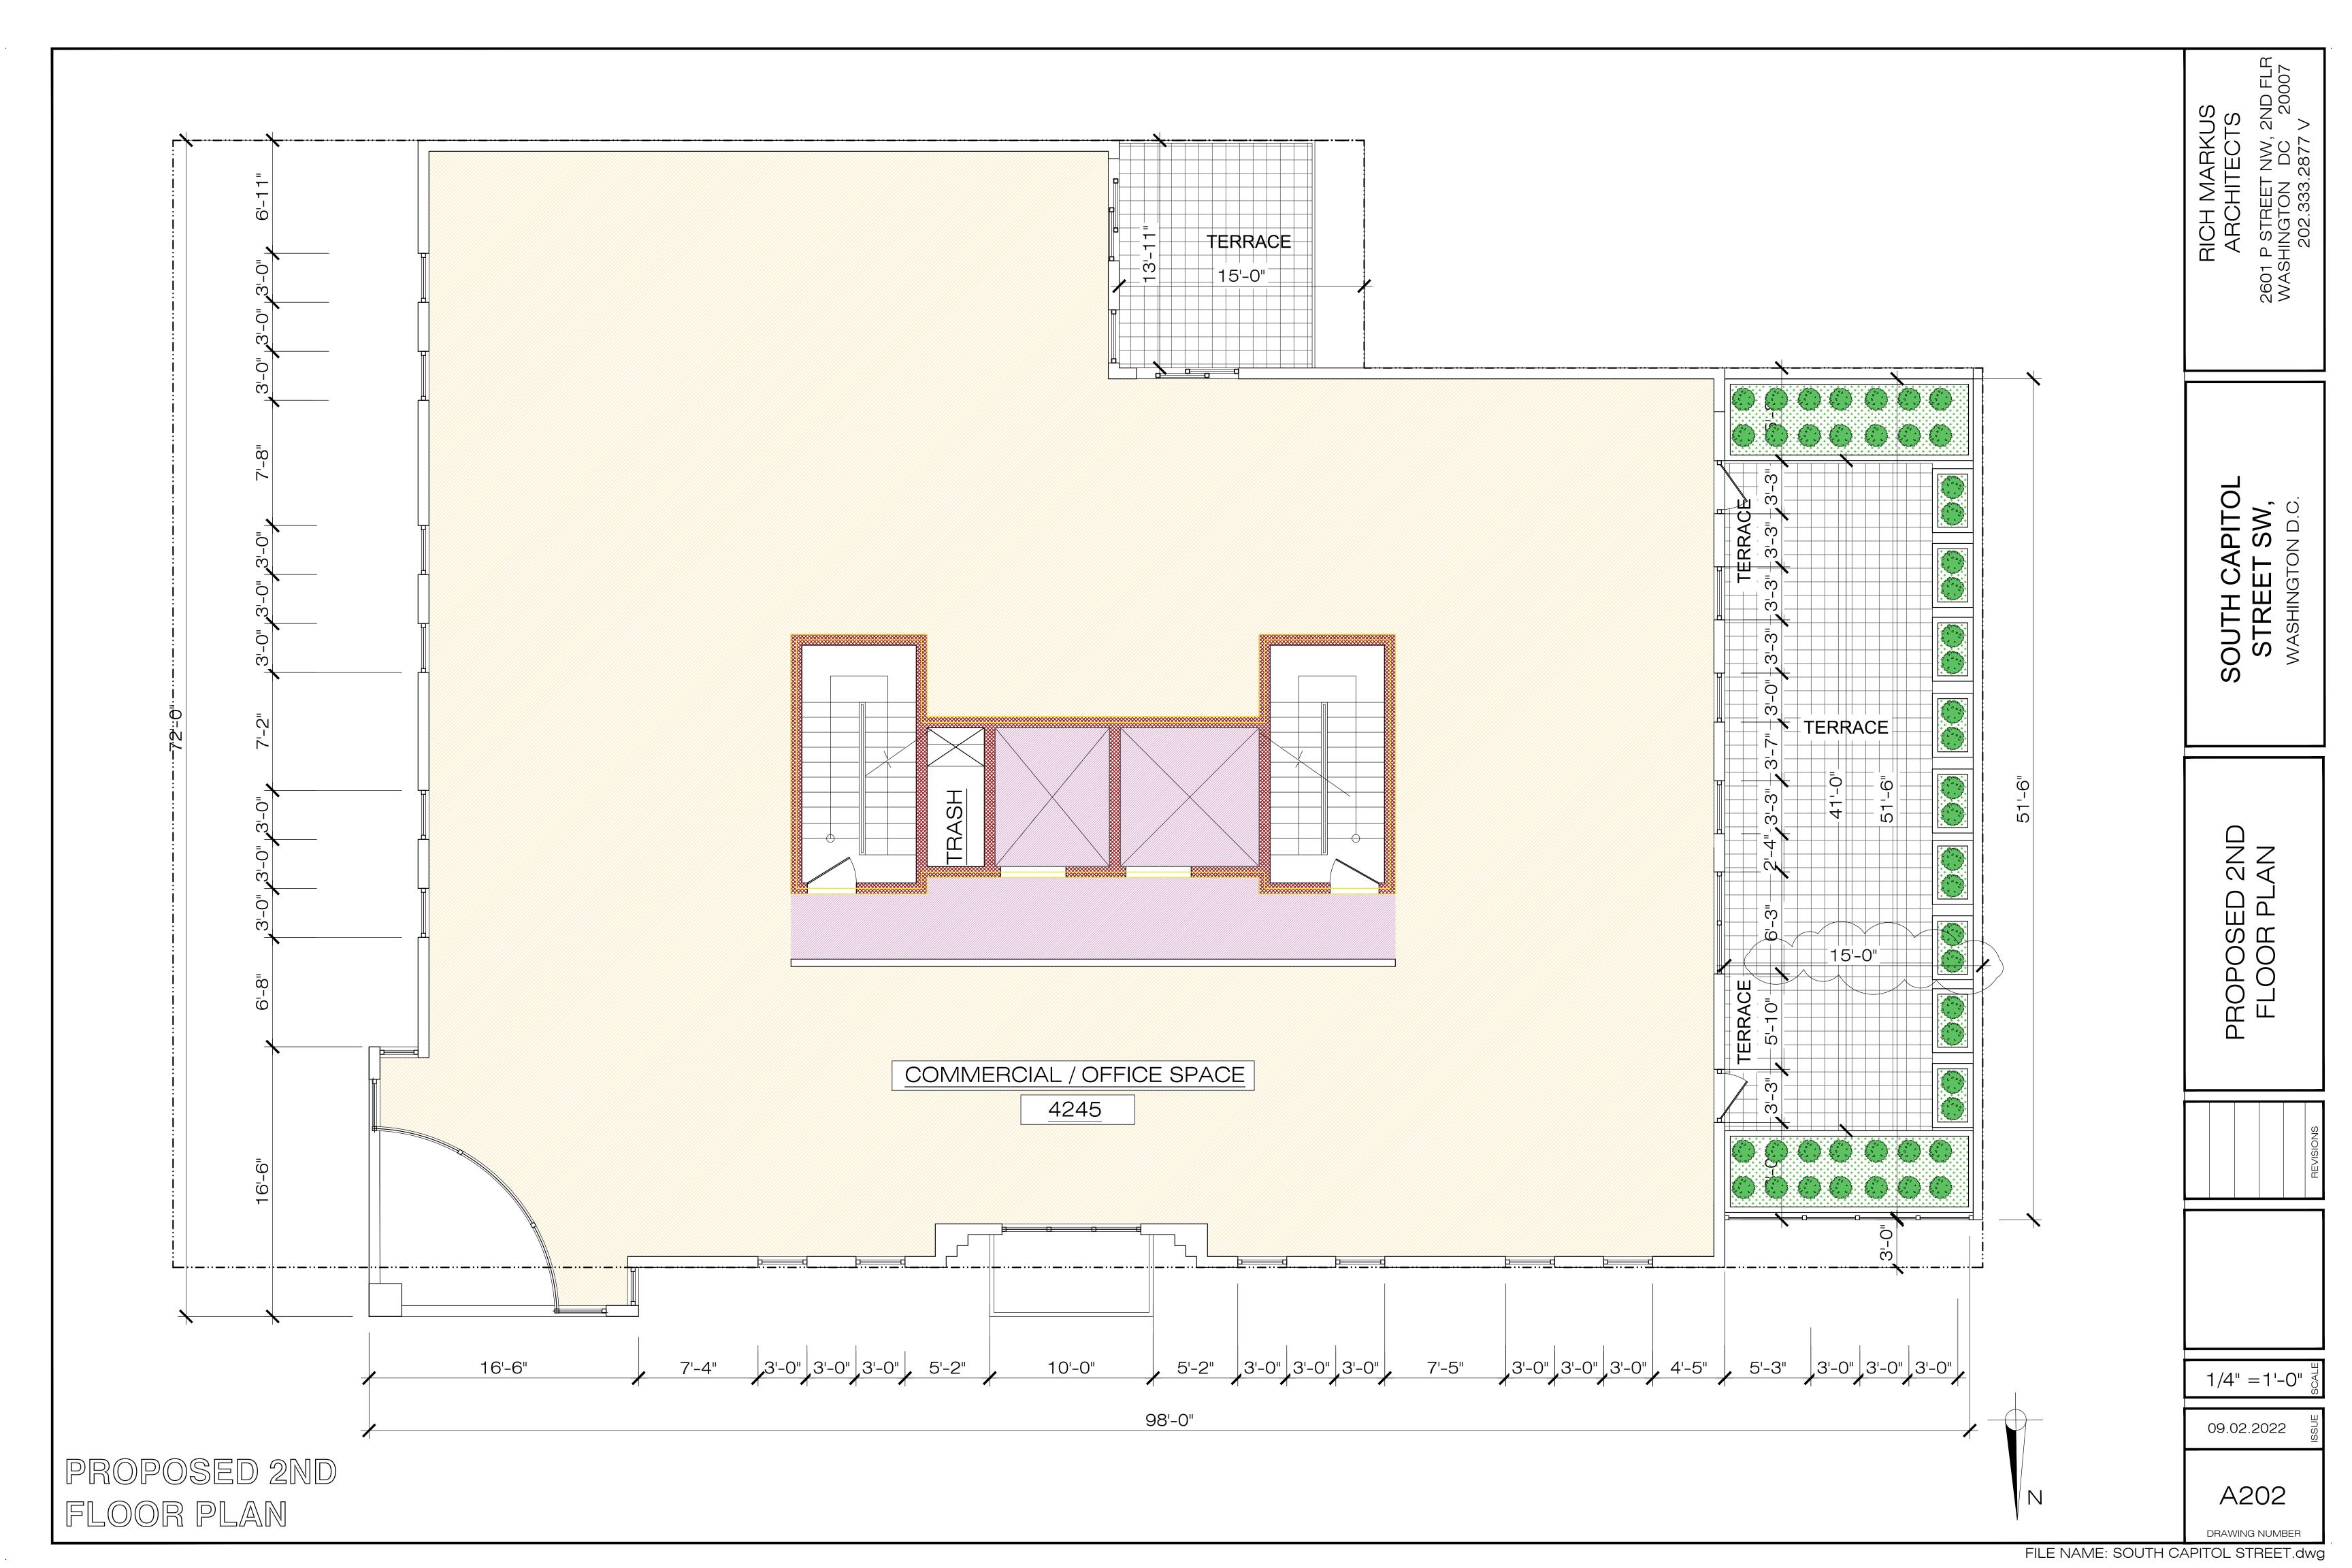SOLAR CALCULATION.

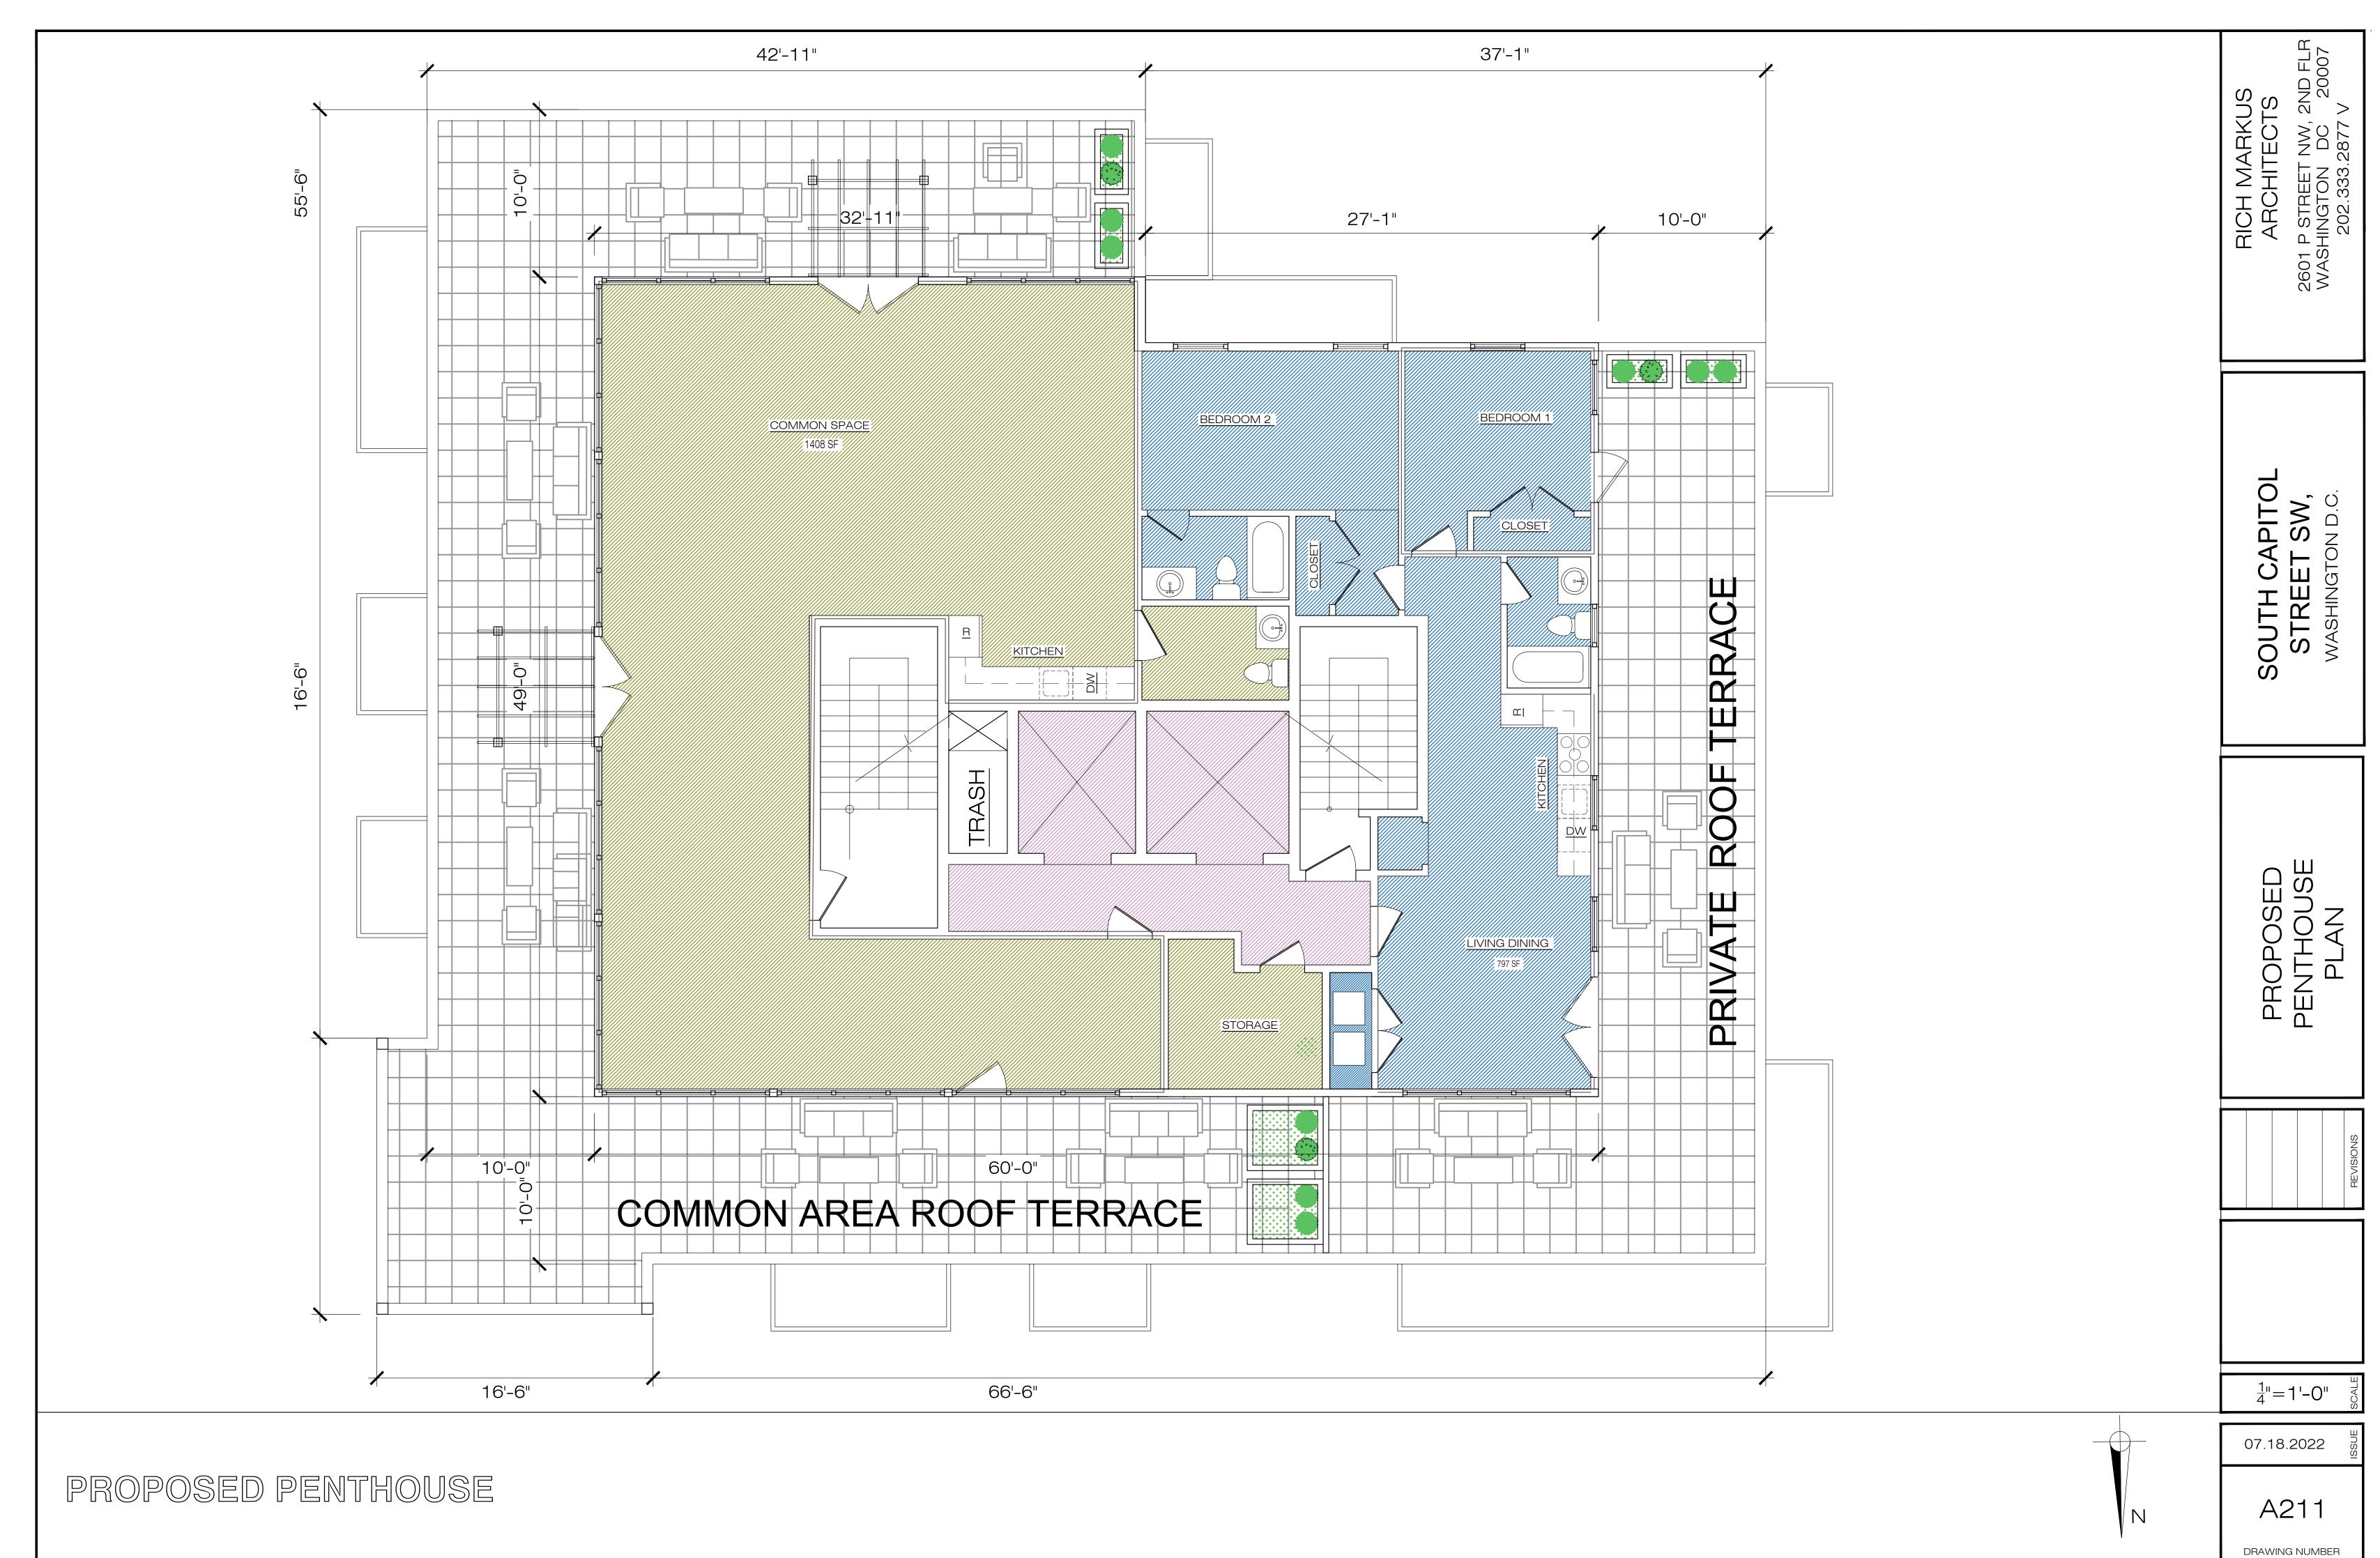

GREEN ROOF & SOLAR PANELS

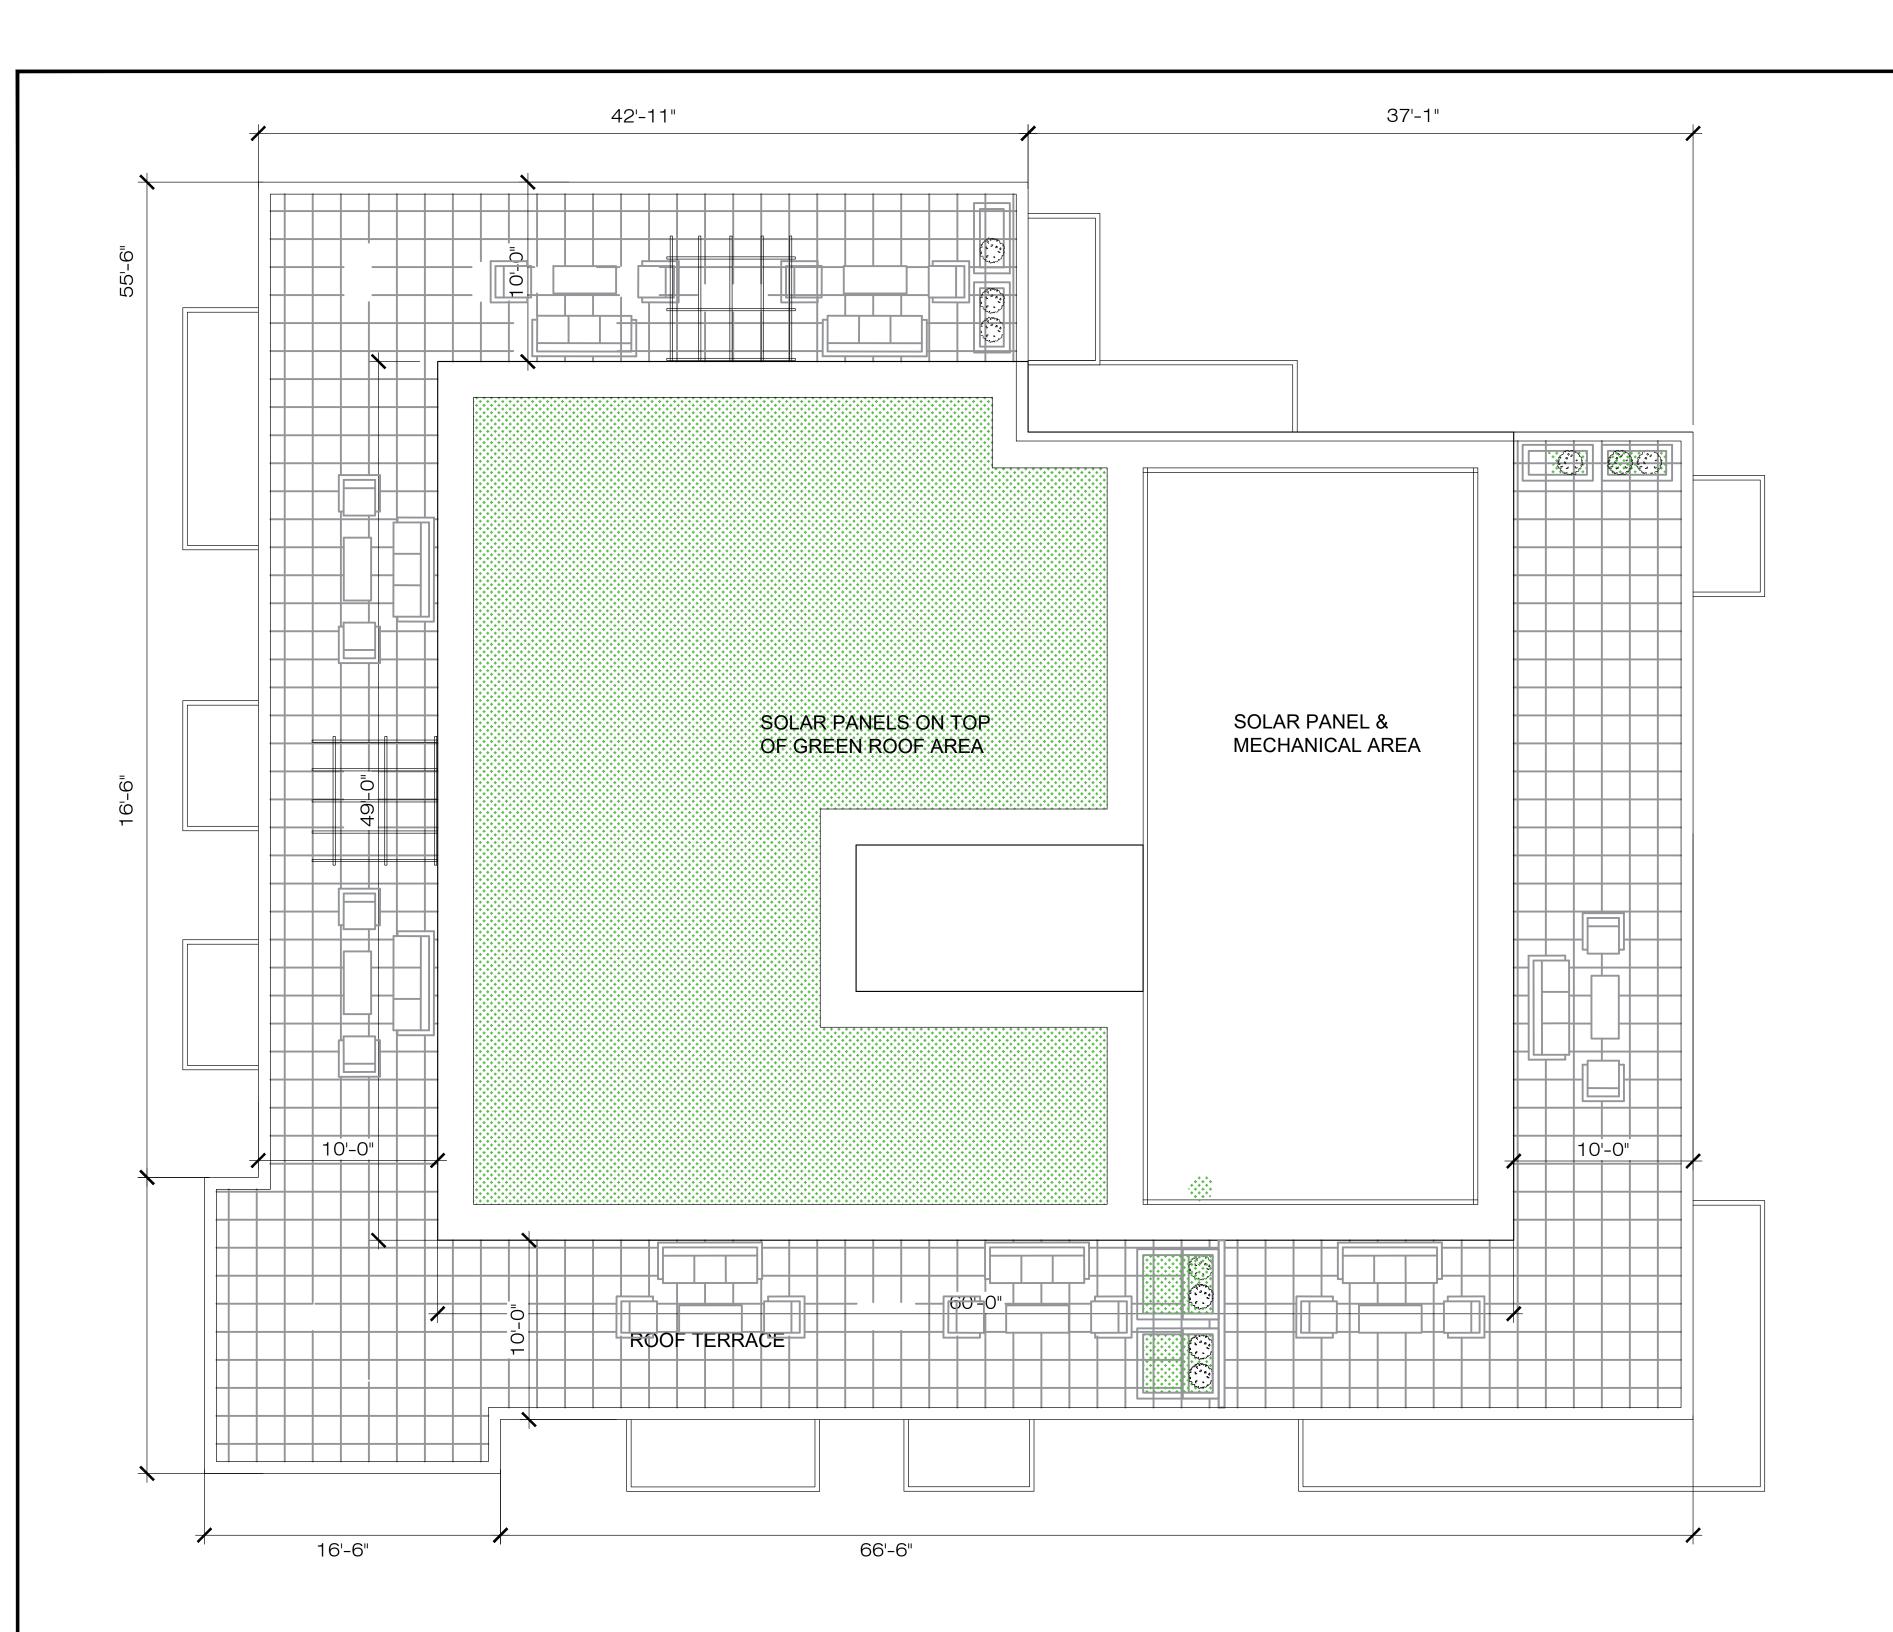

SOLAR PANEL SUPPORT SYS.

A212







A. GREEN ROOF

B. VEGETATED WALL

C. STONE / CONCRETE PAVEMENT

Address S Capitol St SW Zone District Square CG-2 827,829,830 **GAR Score** 0.305 Lot size (enter this value first) * Landscape Elements A Landscaped areas (select one of the following for each area) 57.0 Landscaped areas with a soil depth < 24" Landscaped areas with a soil depth ≥ 24" Vegetated or "green" roofs Bioretention facilities square feet square feet. Over at least 2" and less than 8" of growth medium 70 42.0 70 0.60 B Plantings (credit for plants in landscaped areas from Section A) square feet square feet Native Bonus 1,762 Over at least 8" of growth medium 1,762 1,409.6 0.80 square feet square feet Groundcovers, or other plants < 2' height 0.20 Permeable Paving*** # of plants # of plants Plants ≥ 2' height at maturity 40.5 15 15 square feet Permeable paving over 6" to 24" of soil or gravel 0.40 - calculated at 9-sf per plant square feet N of trees Permeable paving over at least 24" of soil or gravel 631 315.5 0.50 New trees with less than 40-foot canopy spread - calculated at 50 sq ft per tree Other H of trees square feet New trees with 40-foot or greater canopy spread Enhanced tree growth systems*** 0.40 - calculated at 250 sq ft per tree square feet H of trees Renewable energy generation 0.50 Preservation of existing tree 6" to 12" DBH 0.70 square feet - calculated at 250 sq ft per tree Approved water features 0.20 H of trees Preservation of existing tree 12" to 18" DBH 0.70 sub-total of sq ft = 2,928 - calculated at 600 sq ft per tree Bonuses # of trees square feet Preservation of existing trees 18" to 24" DBH 0.10 2,107 Native plant species 210.7 - calculated at 1300 sq ft per tree square feet Landscaping in food cultivation 0.10 # of trees Preservation of existing trees 24" DBH or greater square feet - calculated at 2000 sq ft per tree Harvested stormwater irrigation 2,159 Green Area Racio numerator -Vegetated wall, plantings on a vertical surface 140 140 84.0 *** Permeable paving and structural soil together may not qualify for more than one third of the Green Area Ratio score. 0.60 Total square footage of all permeable paving and enhanced tree growth.

GAR SCORDHEET

SOUTH CAPITOL STREET SW,

GAR

		REVISIONS


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AS SHOWN

06.13.2022

A213


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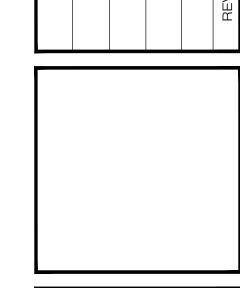


RICH MARKUS ARCHITECTS
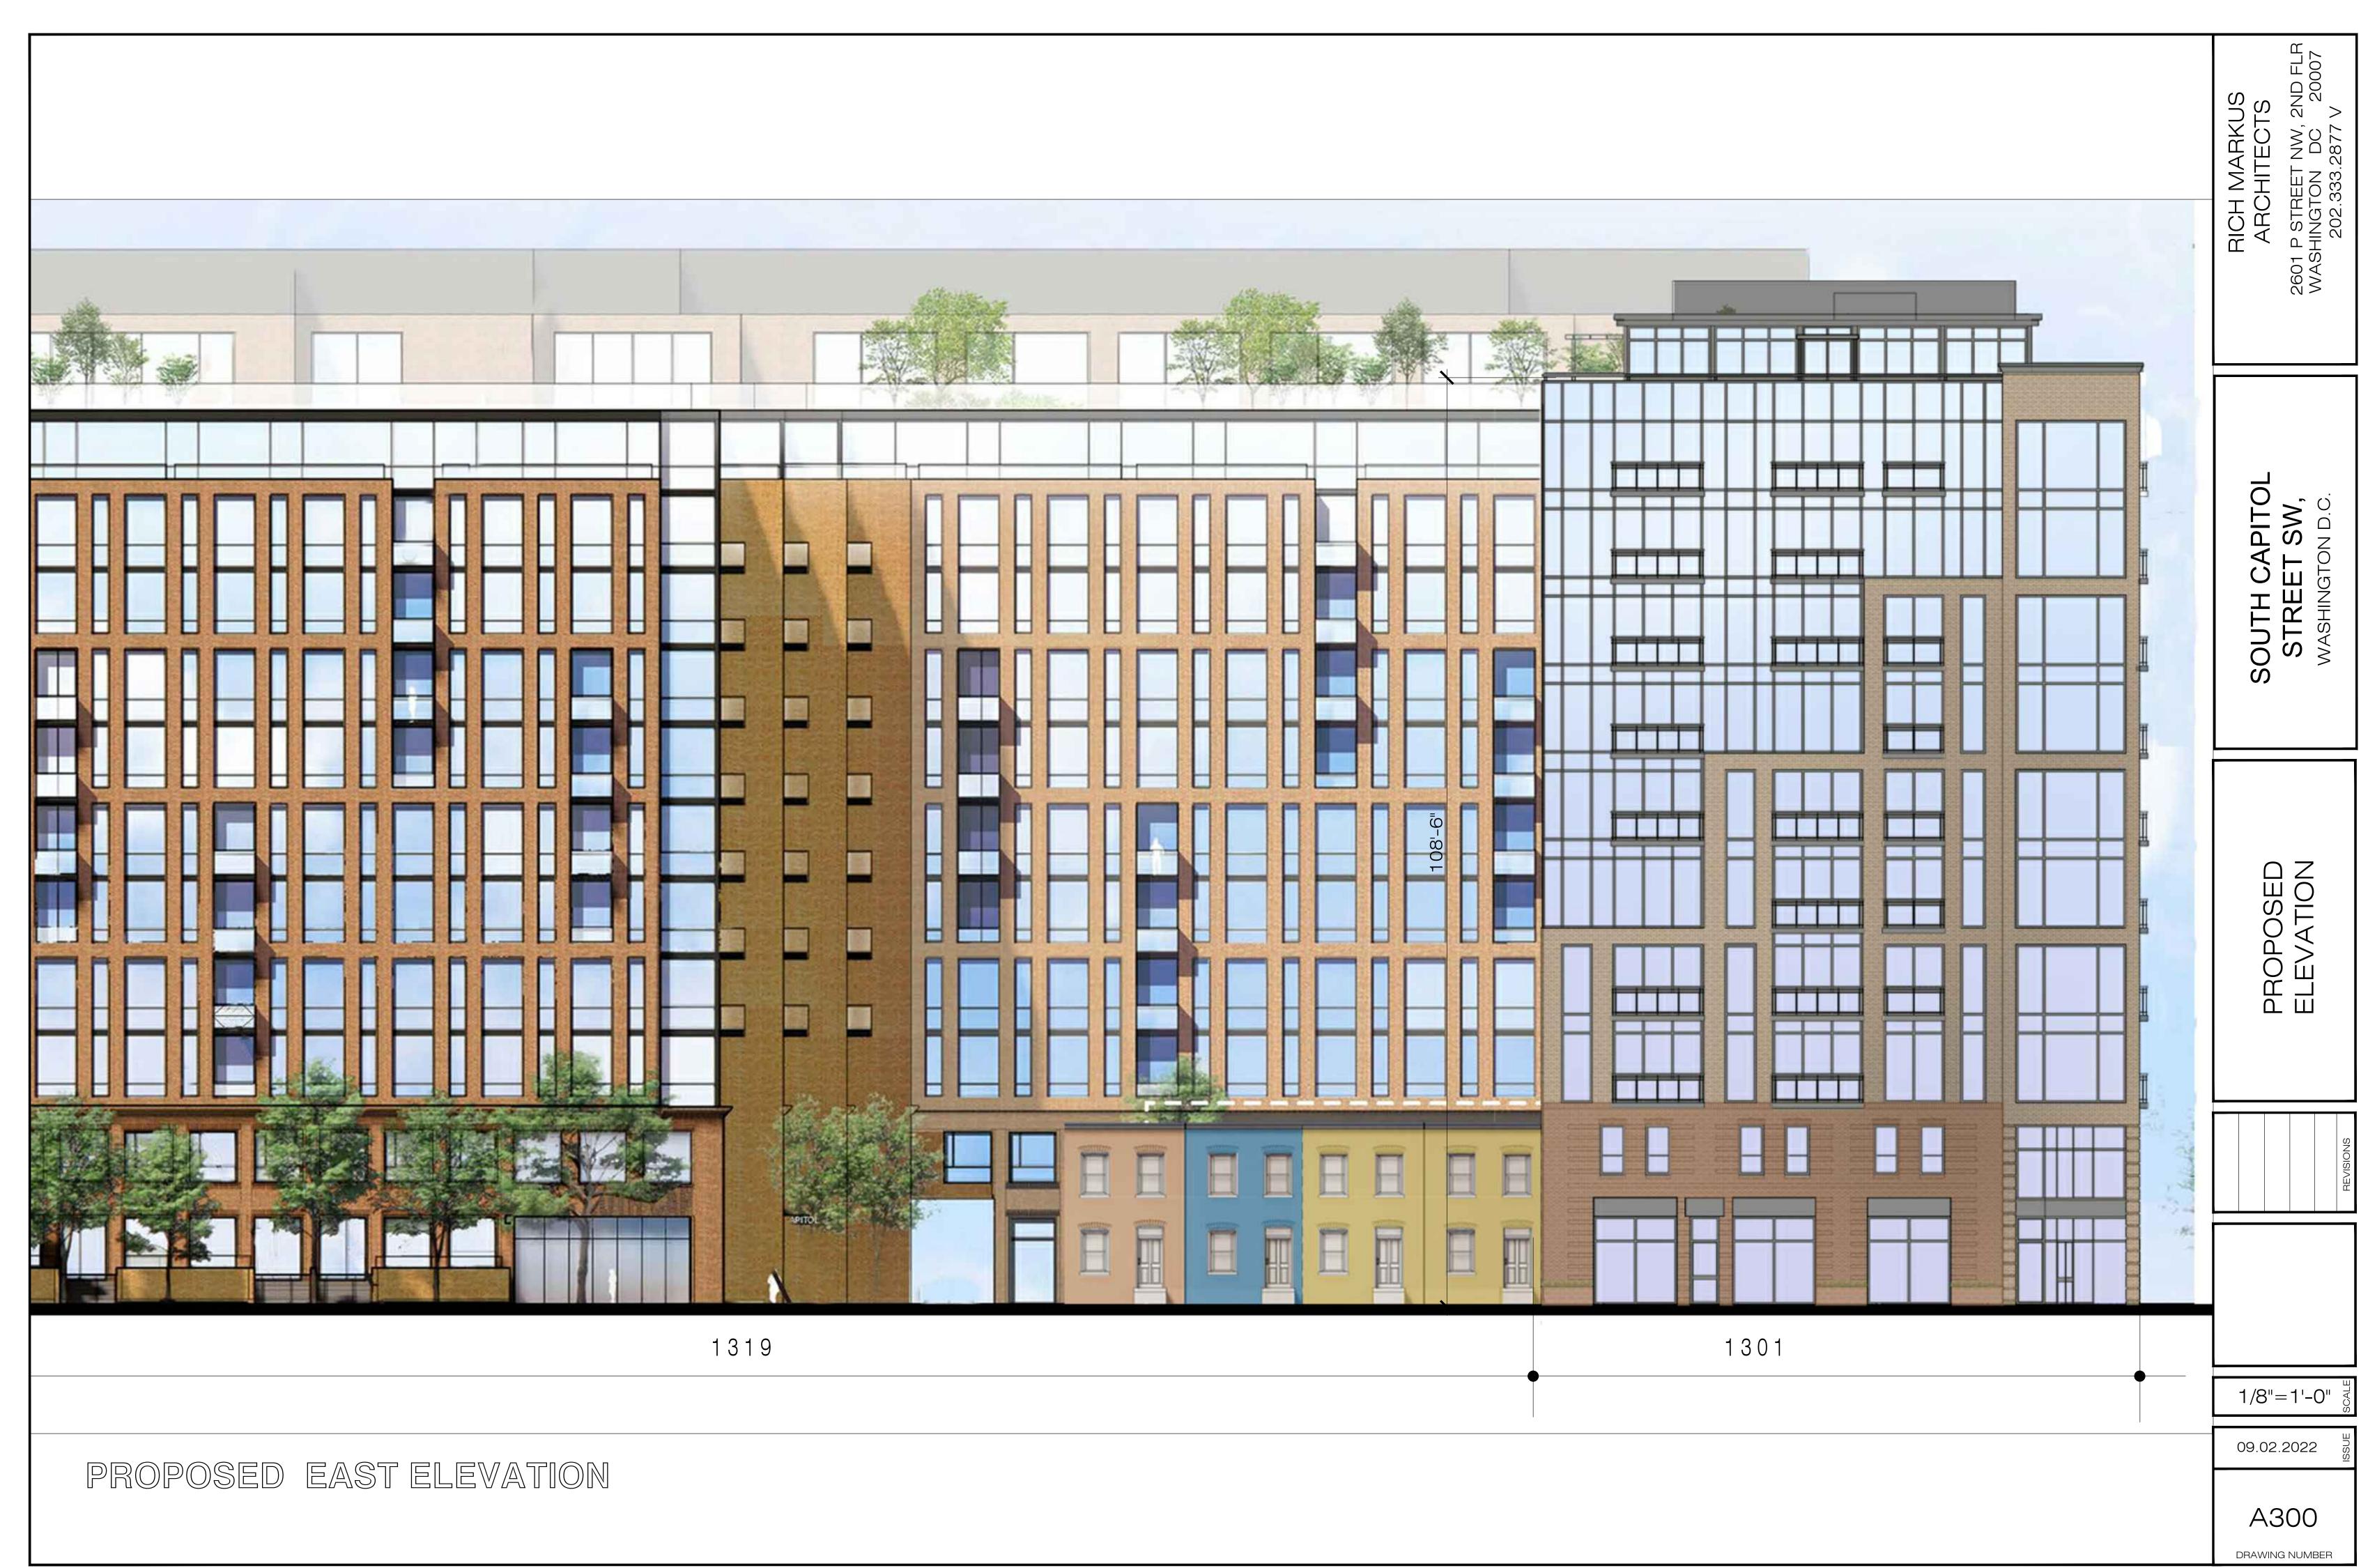
> SOUTH CAPITOL STREET SW, WASHINGTON D.C.

PROPOSED



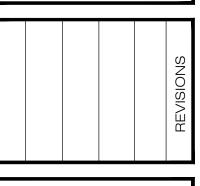

1/8"=1'-0"

09.02.2022

A301

DRAWING NUMBER

PROPOSED NORTH ELEVATION